PROPOSED OFFICE BUILDING

PREPARED FOR

NEW WINDSOR BUSINESS PARK ASSOCIATES

TOWN OF NEW WINDSOR, ORANGE COUNTY, NEW YORK

PREPARED BY

DEWKETT ENGINEERING, PC

187 EAST MARKET STREET RHINEBECK, NY

APPLICANT
NEW WINDSOR BUSINESS PARK ASSOCIATES
147-39 175TH STREET


JAMAICA, NY 11434


PH: (718) 995-4577


FAX: (718) 244-1141

| SHEET | PAGE | TITLE |
|-----------|------|--------------------------------------|
| T1 | 1 | TITLE SHEET |
| SP1 | 2 | EXISTING CONDITIONS PLAN |
| SP2 | 3 | SITE PLAN |
| SP3 | 4 | UTILITY AND GRADING PLAN |
| SP4 | 5 | SEDIMENT AND EROSION CONTROL PLAN |
| SP5 | 6 | LANDSCAPING AND LIGHTINGPLAN |
| D1 | 7 | SITE DETAILS |
| D2 | 8 | STORM SEWER DETAILS |
| D3 | 9 | WATER DETAILS |
| D4 | 10 | SANITARY SEWER DETAILS |
| D5 | 11 | SEDIMENT AND EROSION CONTROL DETAILS |

REPRODUCTION OF THIS DOCUMENT IN WHOLE OR IN PART IS PROHIBITED EXCEPT WITH THE PERMISSION OF THE OFFICE OF ORIGIN.
UNAUTHORIZED ALTERATION OR ADDITION TO THIS PLAN IS A VIOLATION OF SECTION 7209 (2) OF THE NEW YORK STATE EDUCATION LAW.

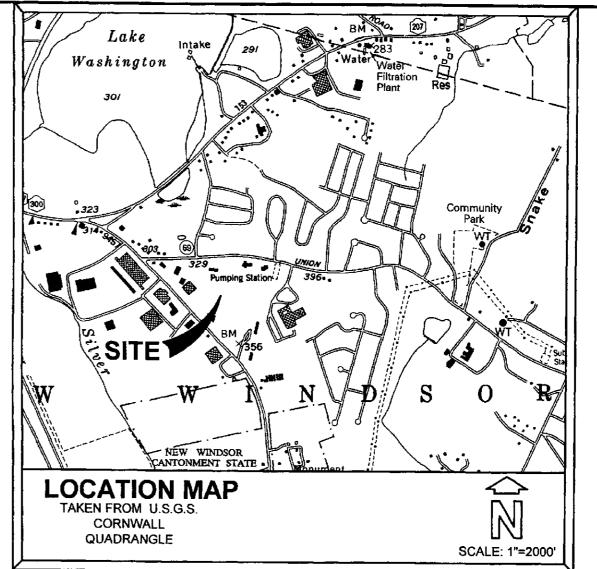

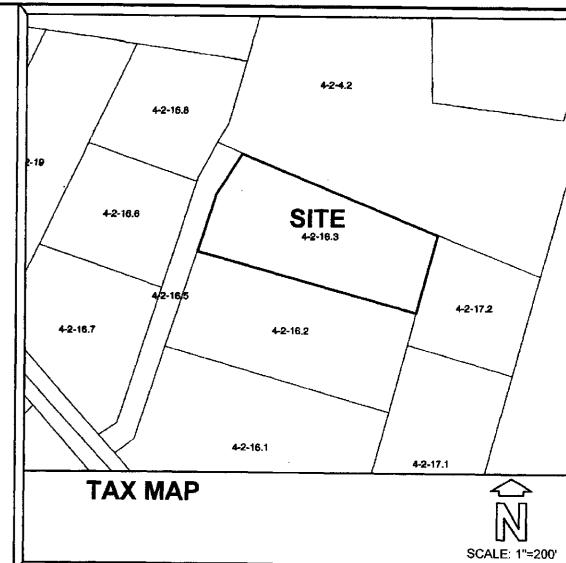

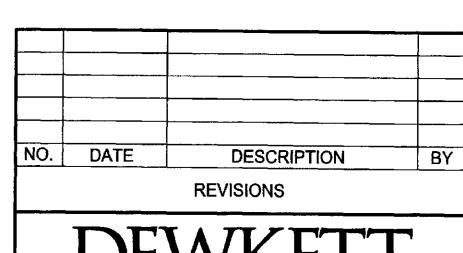

187 E. Market St., Ste 101, Rhinebeck, N.Y. 12572 Phone: (845) 876-5250 Fax: (845) 876-7209

www.dewkett.com

PROJECT NAME:

NEW WINDSOR BUSINESS PARK

PROPOSED OFFICE BUILDING

TOWN OF NEW WINDSOR

Prepared for:
NEW WINDSOR BUSINESS PARK ASSOCIATES

TITLE OF DRAWING:

TITLE SHEET

05027.00

| ENGINEER & PLANNING

Date: 06-07-05 File Name: T1-05027 Design By: DEC


e Name: T1-05027 DRAWING NO:


Checked By:
KAD


Drafted By:
DFC


Sheet 1 of 11


pro of A

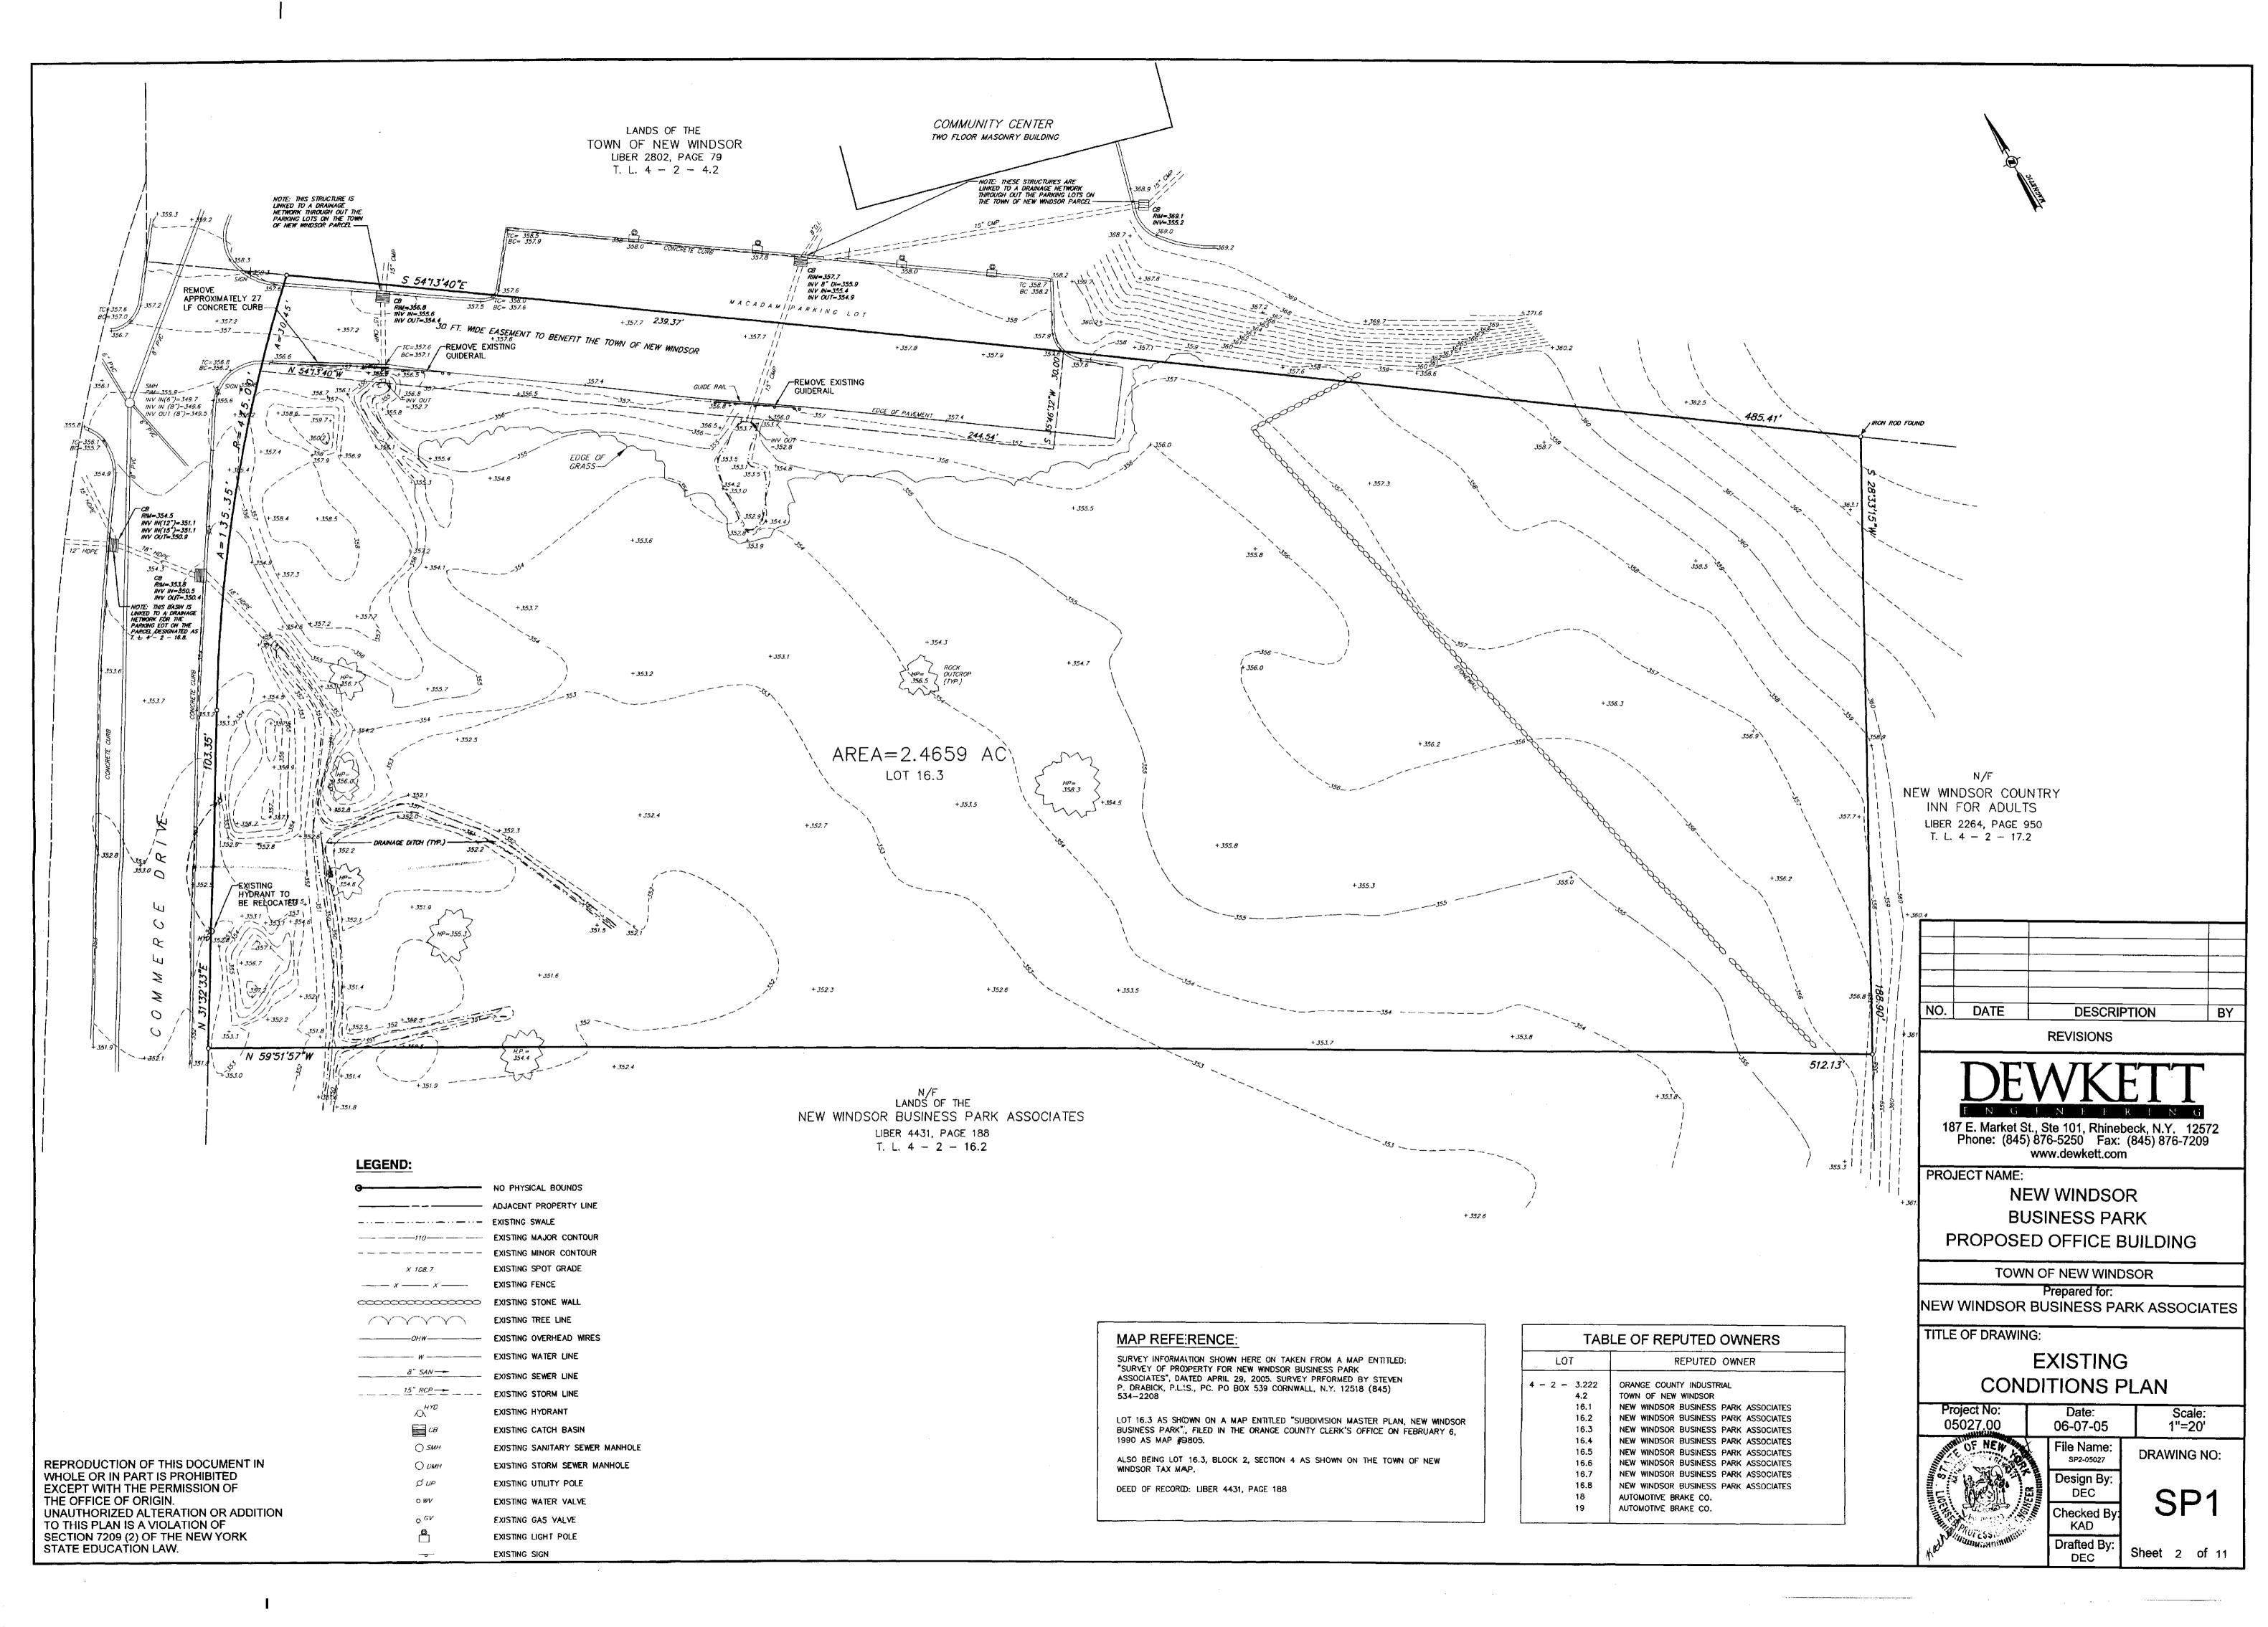


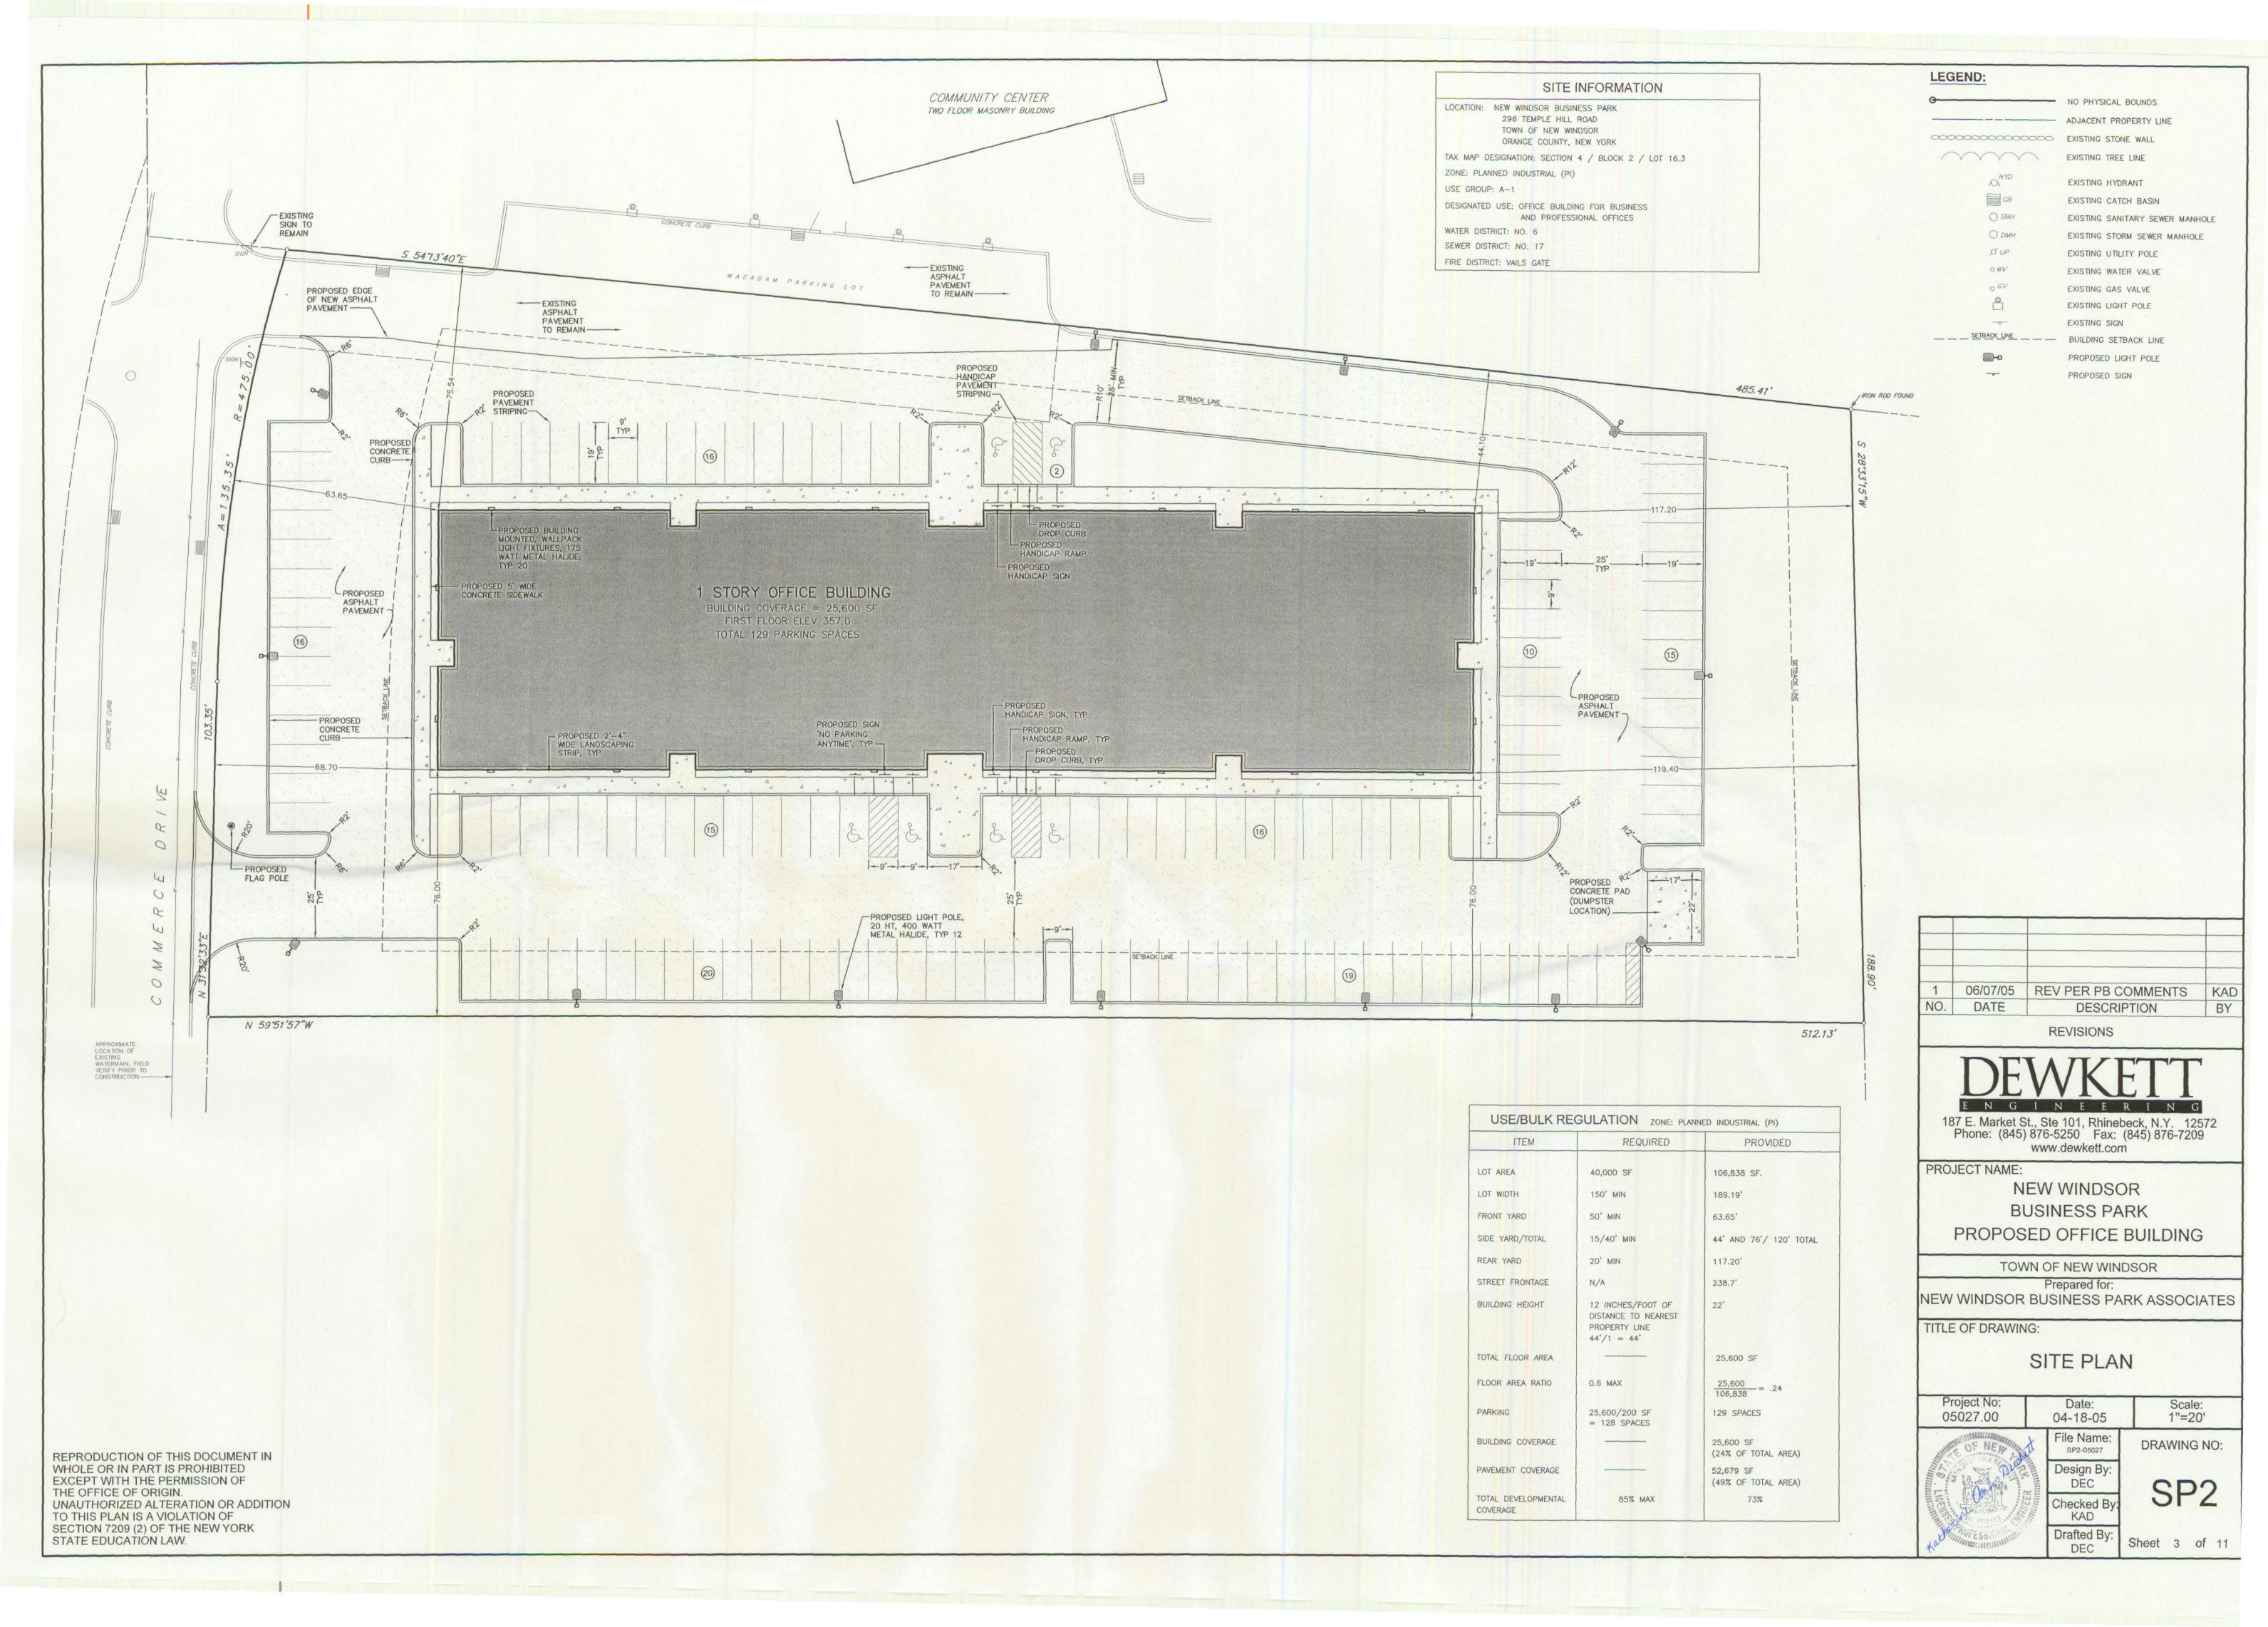


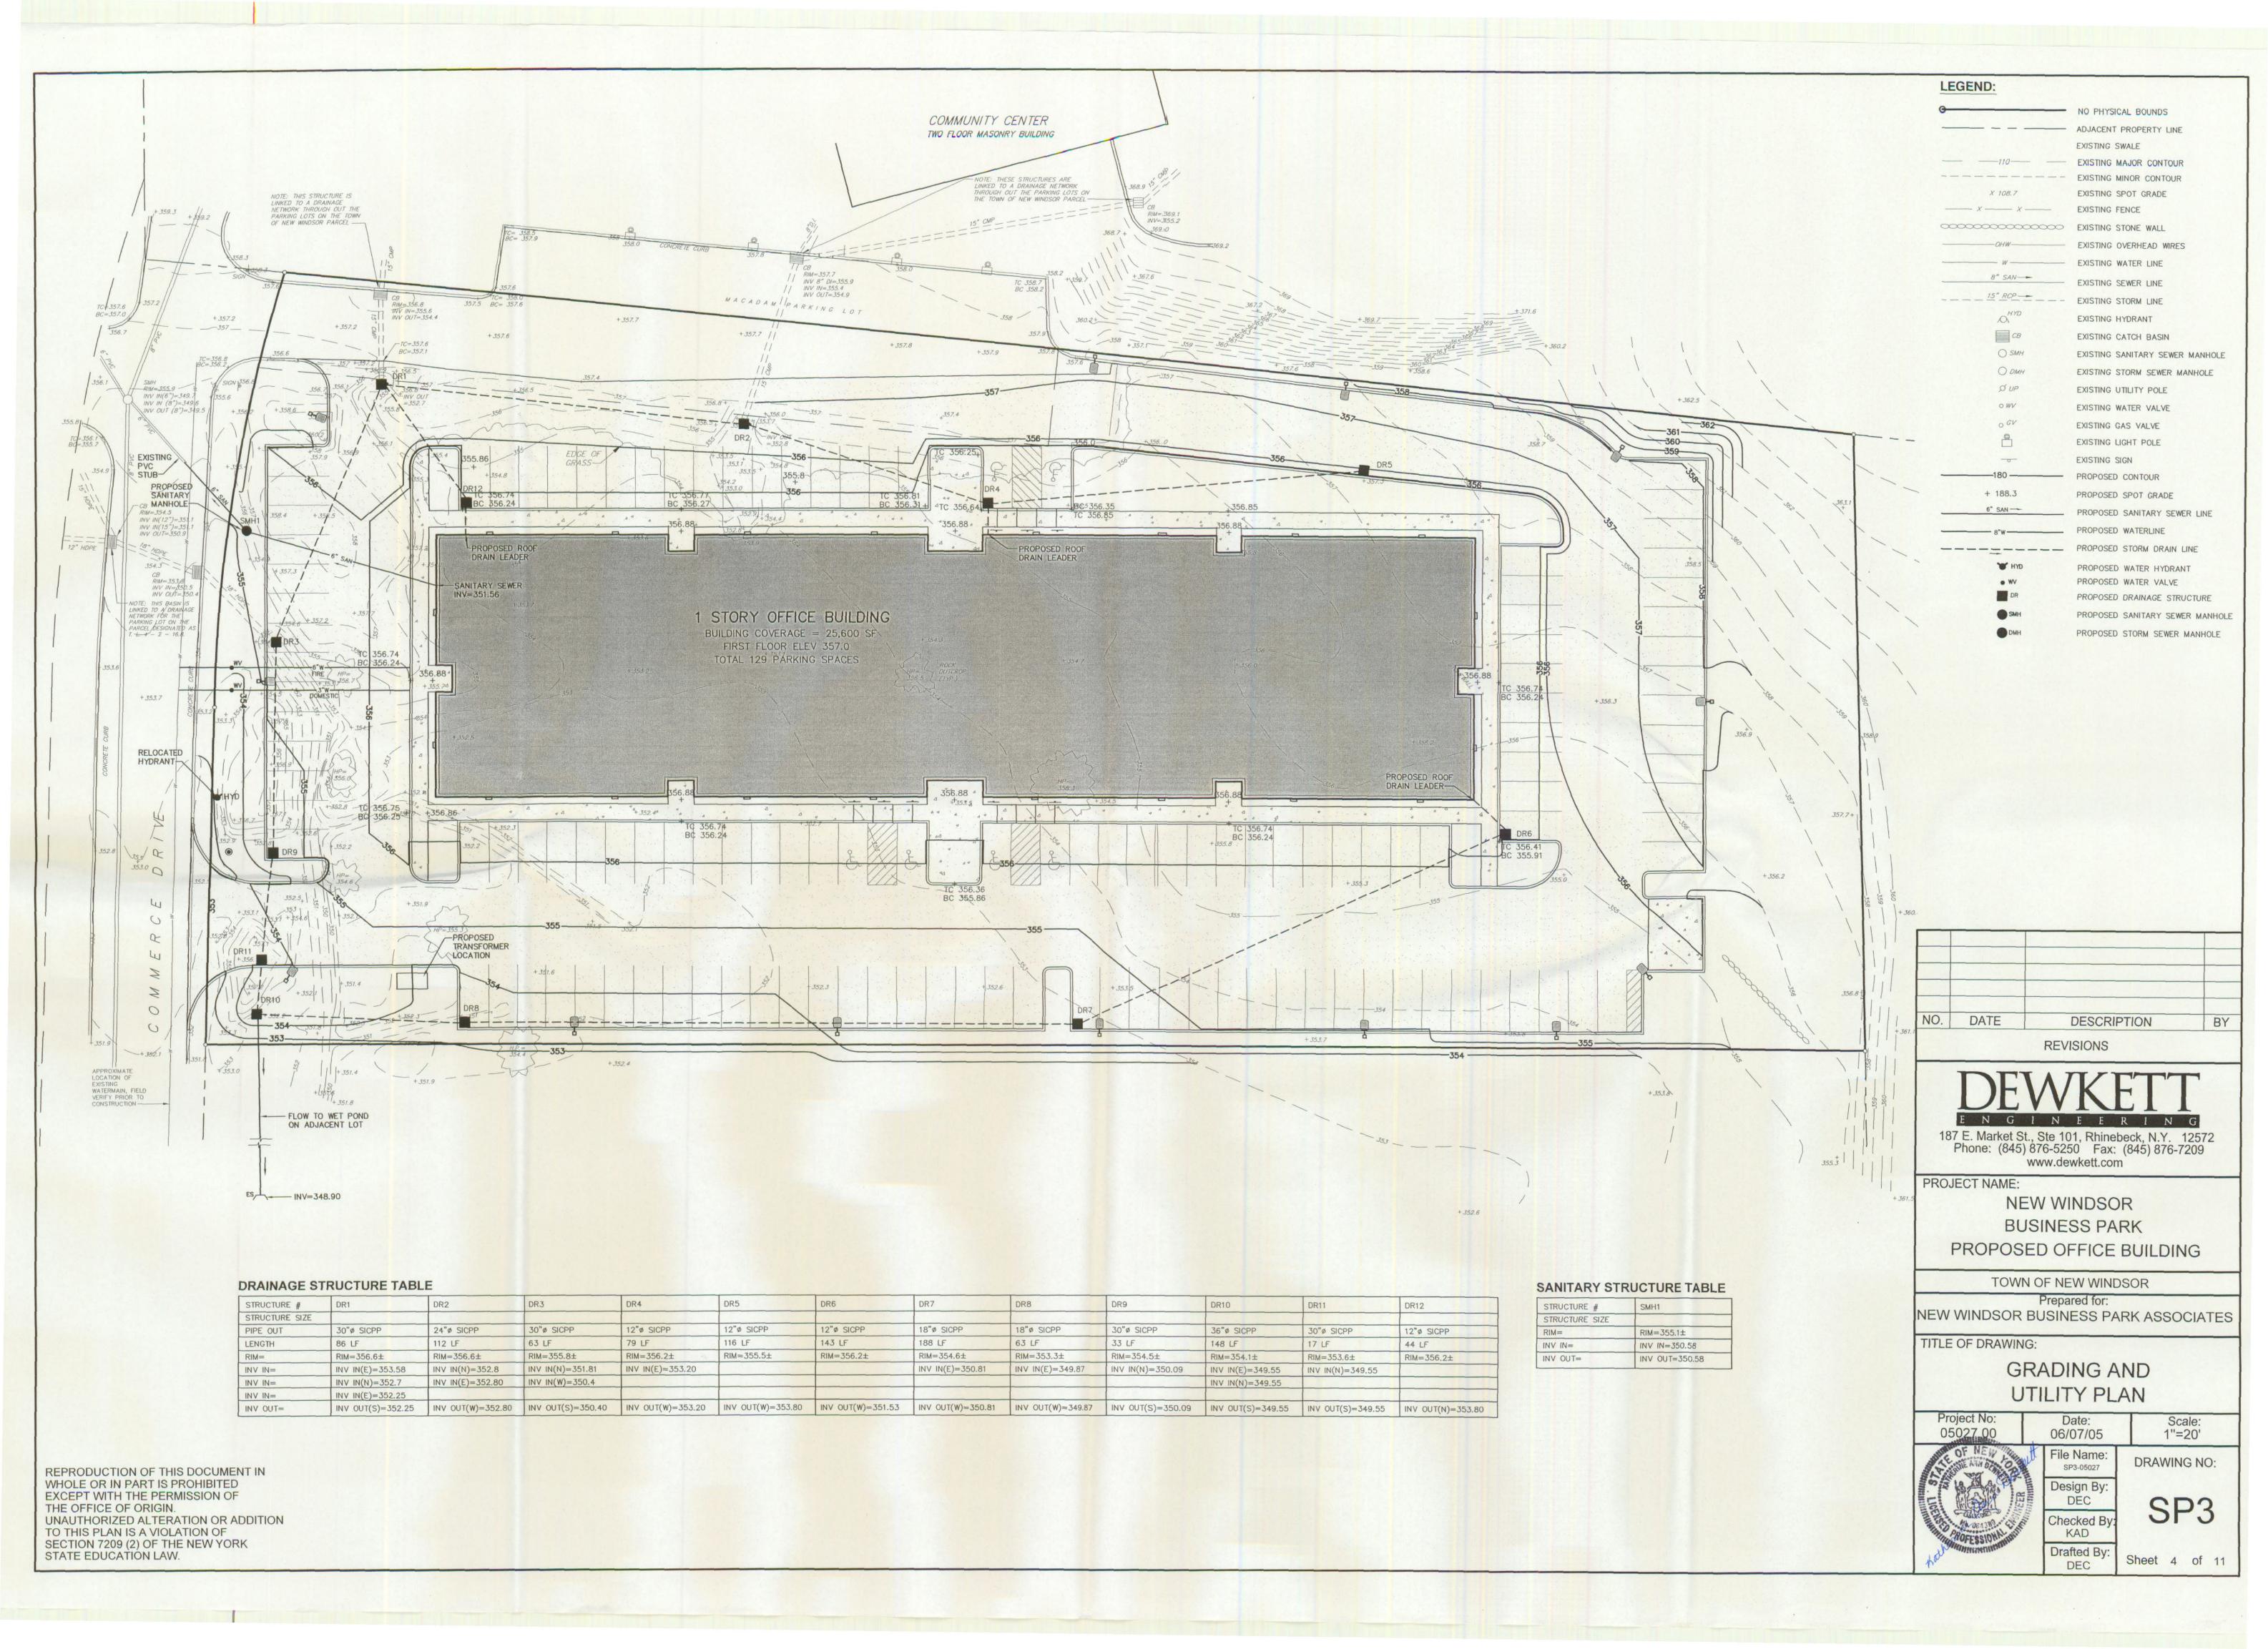

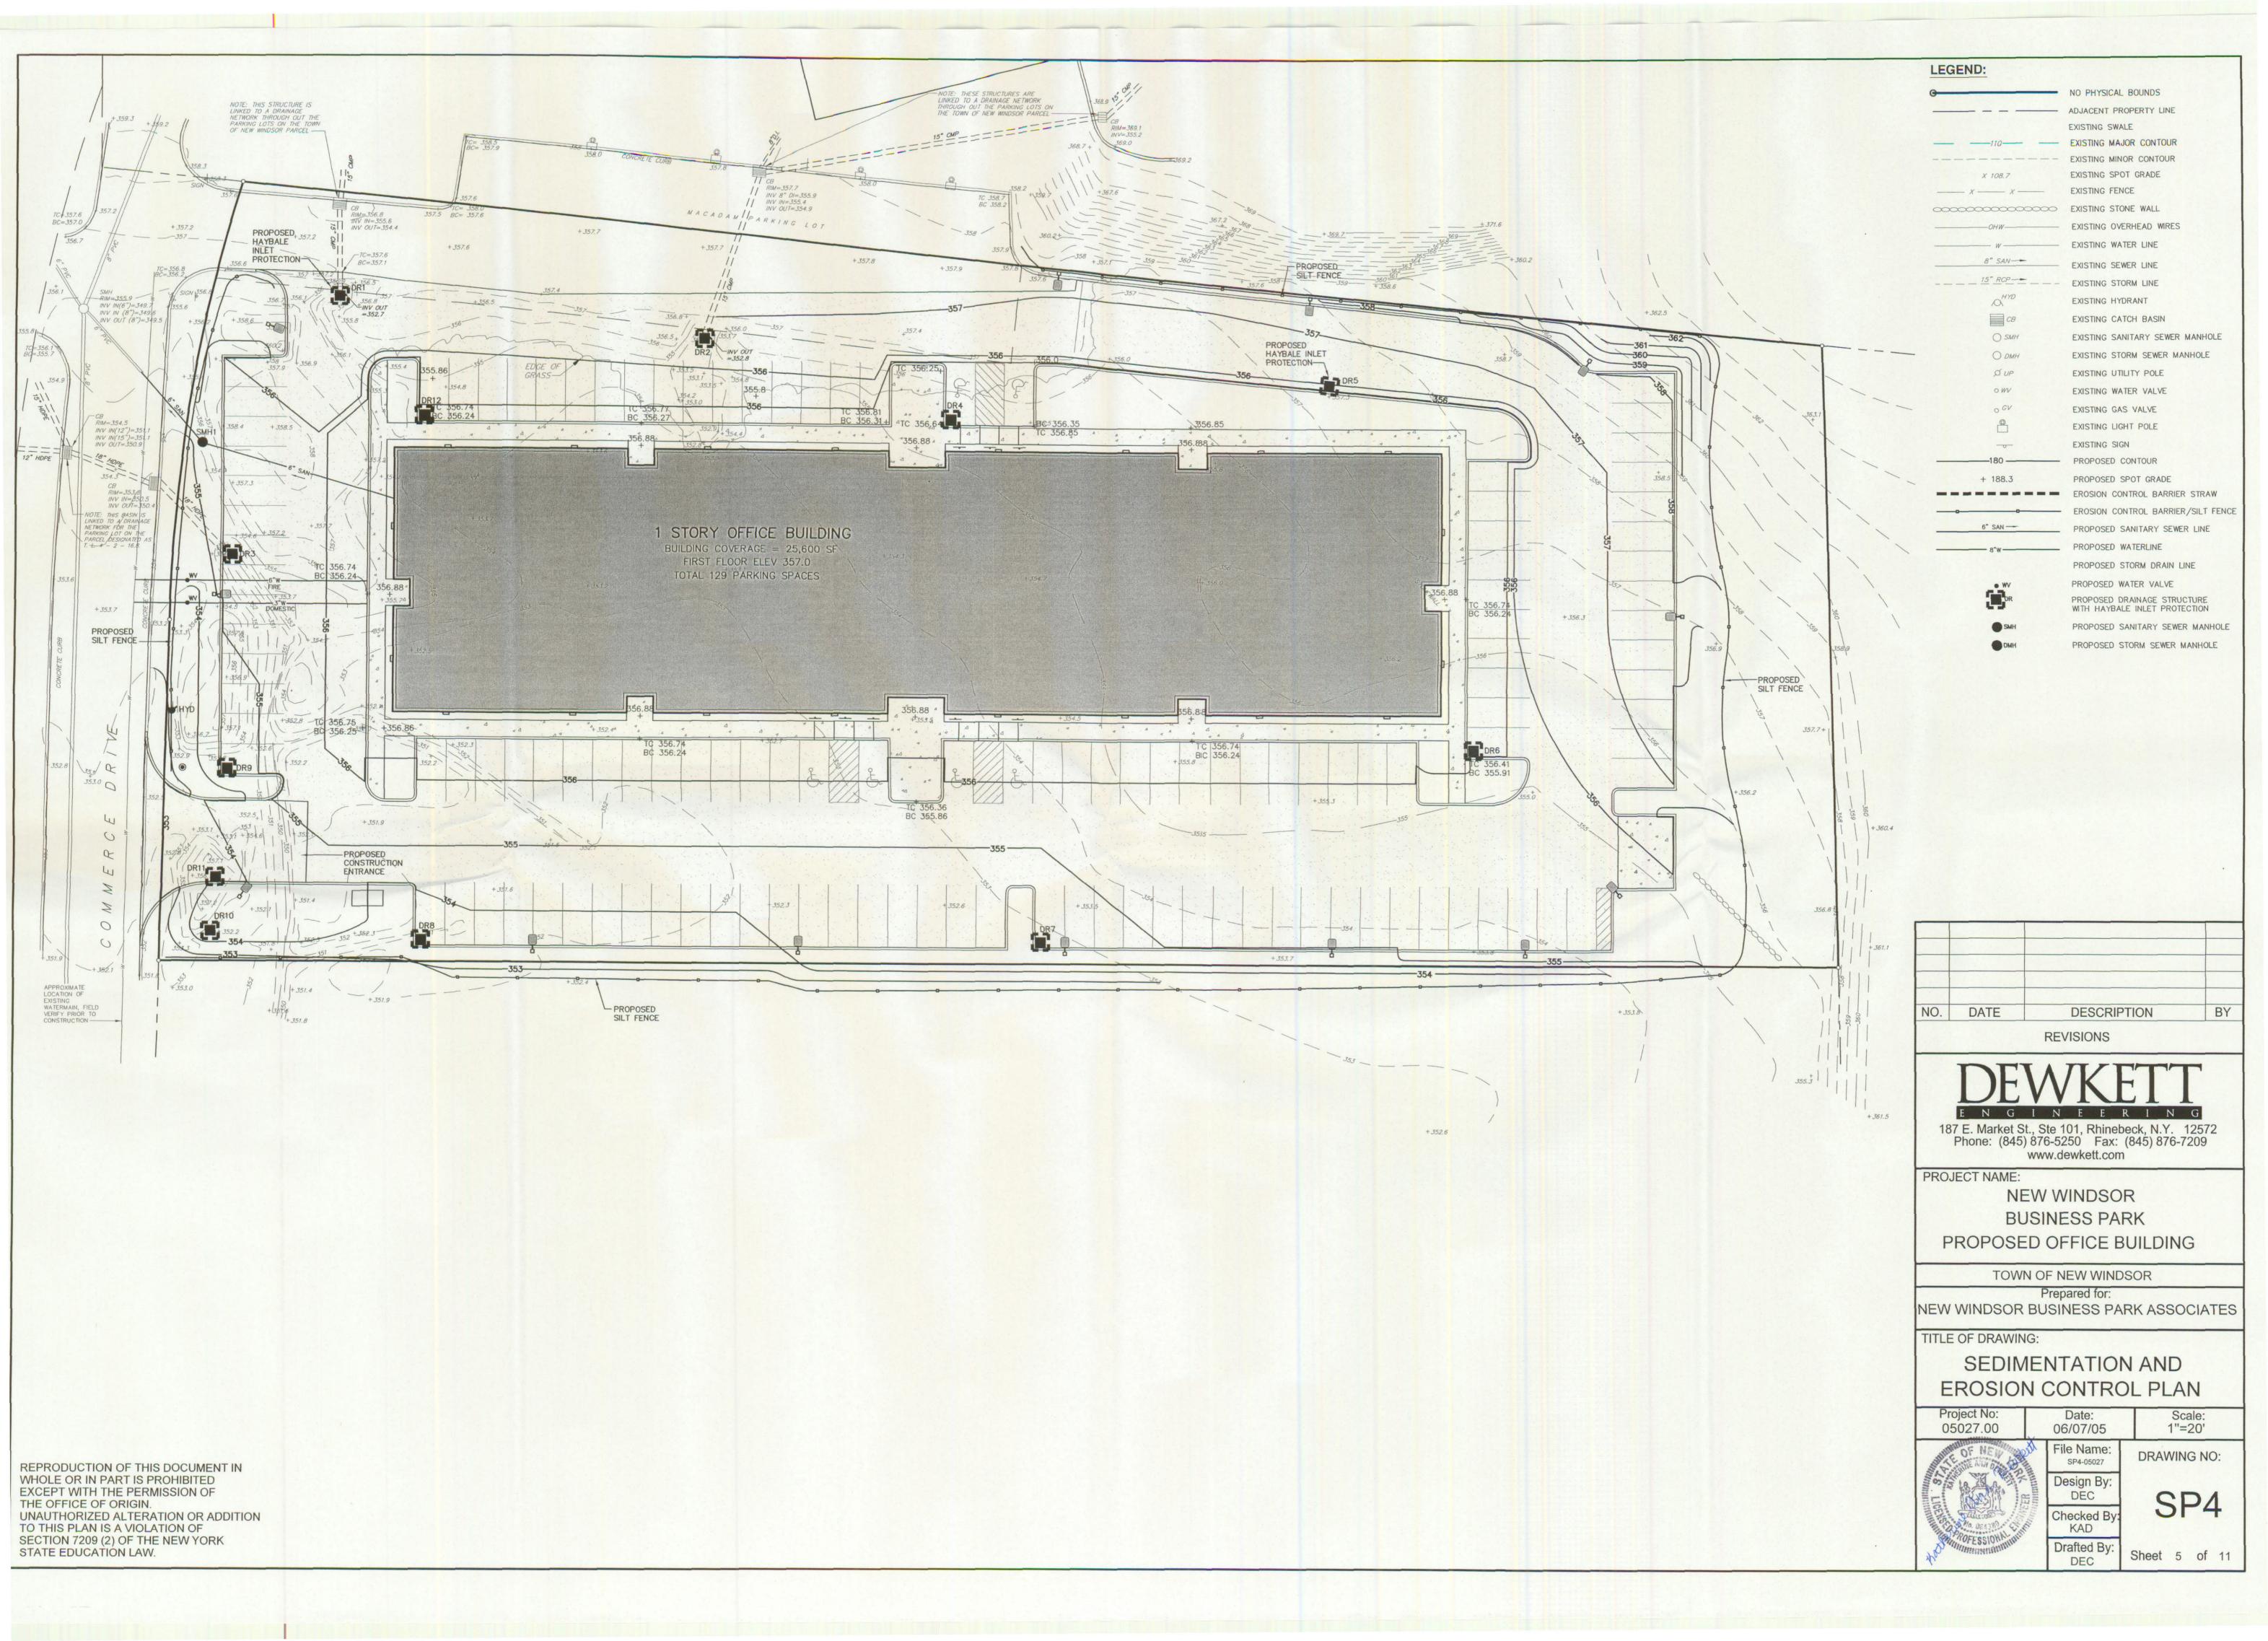

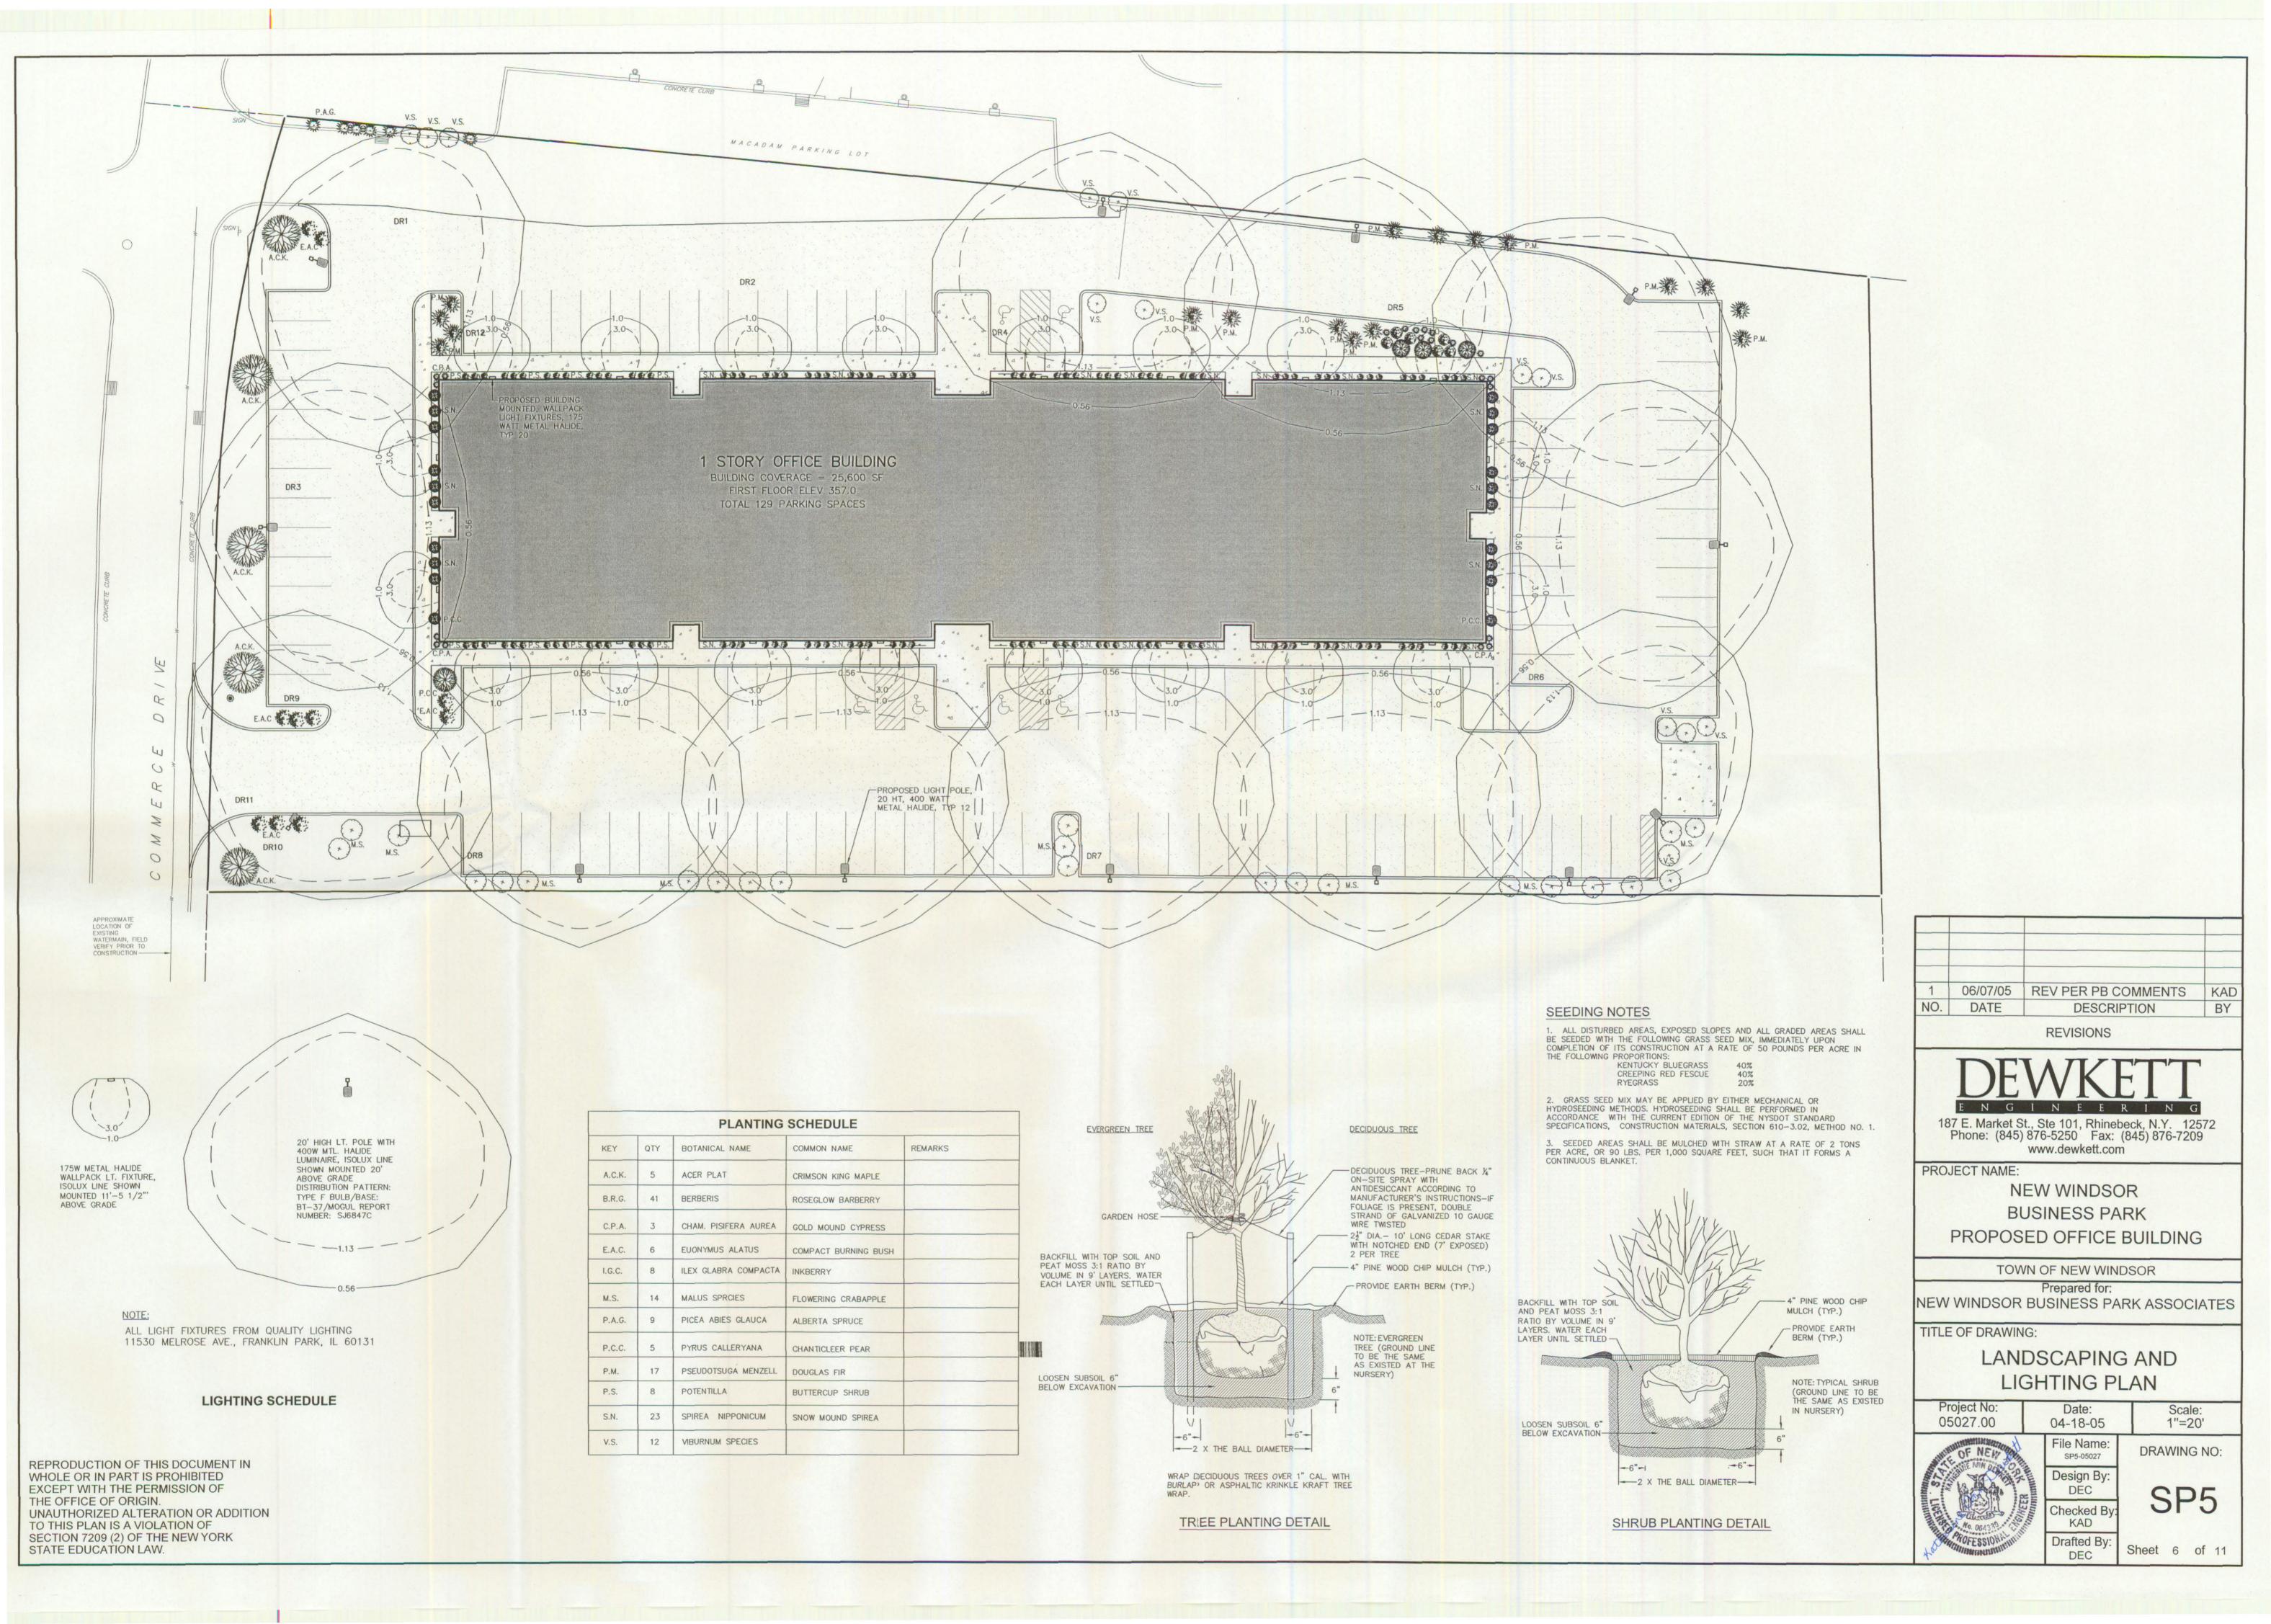

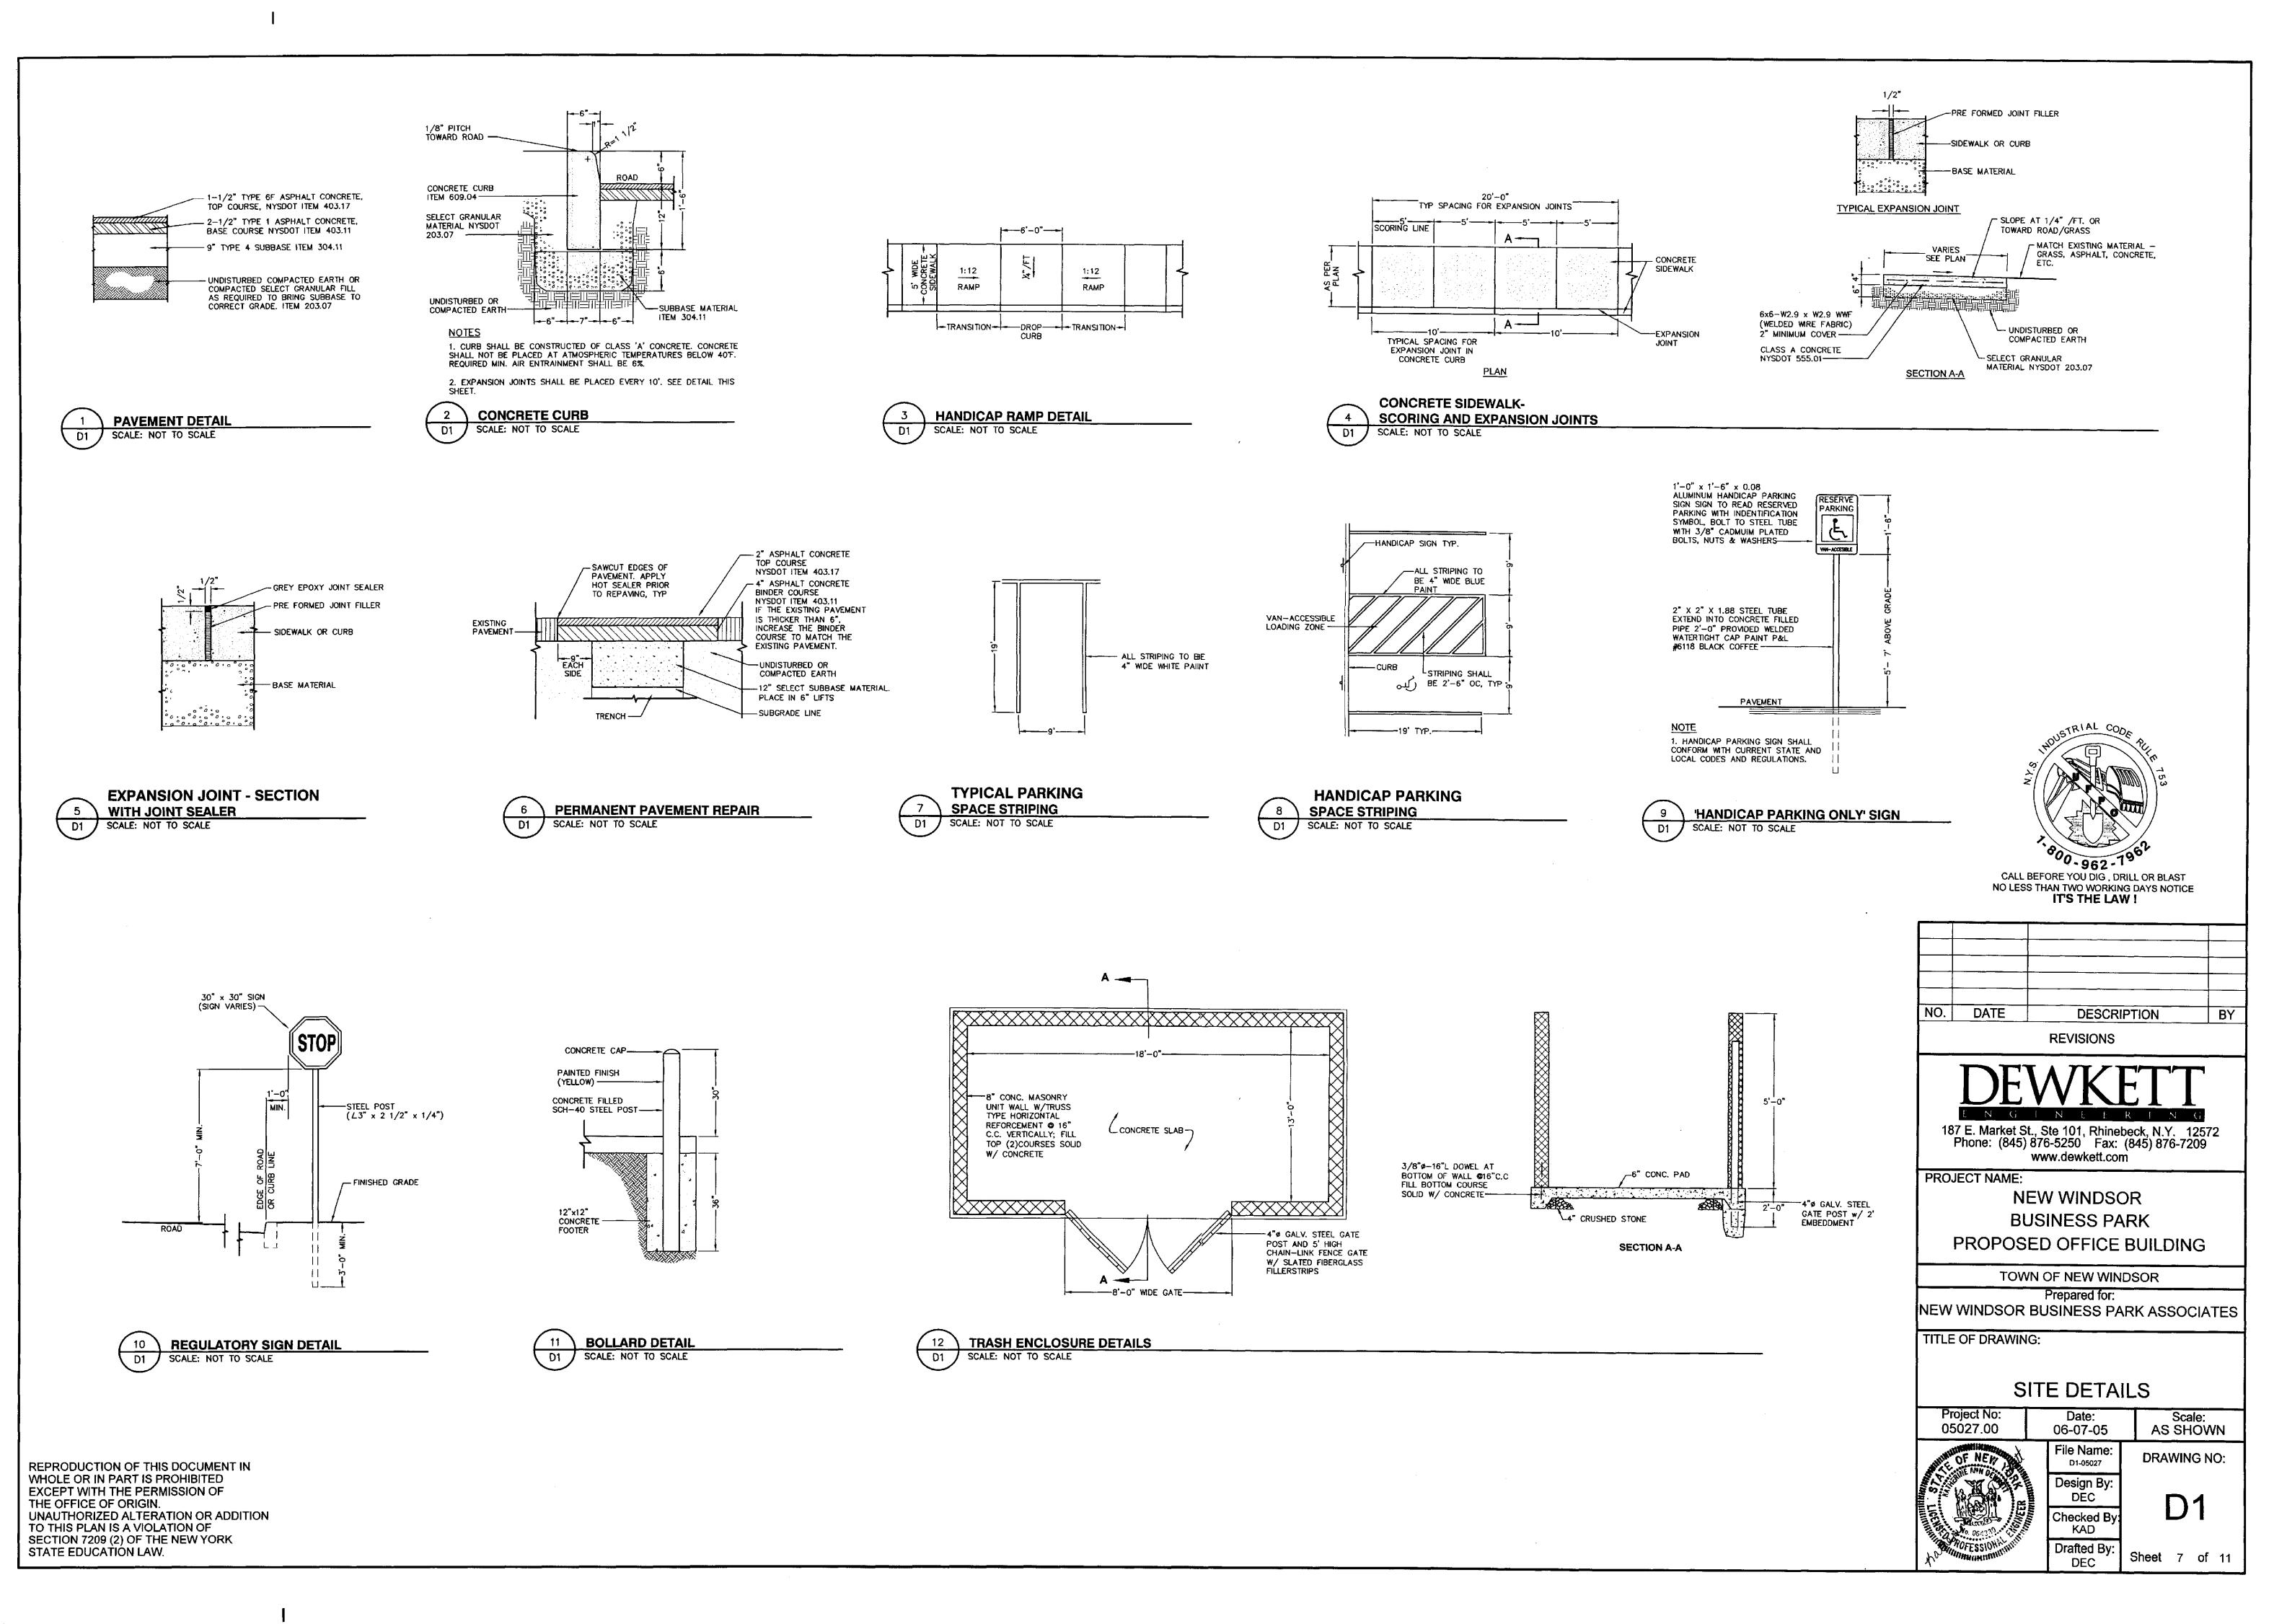

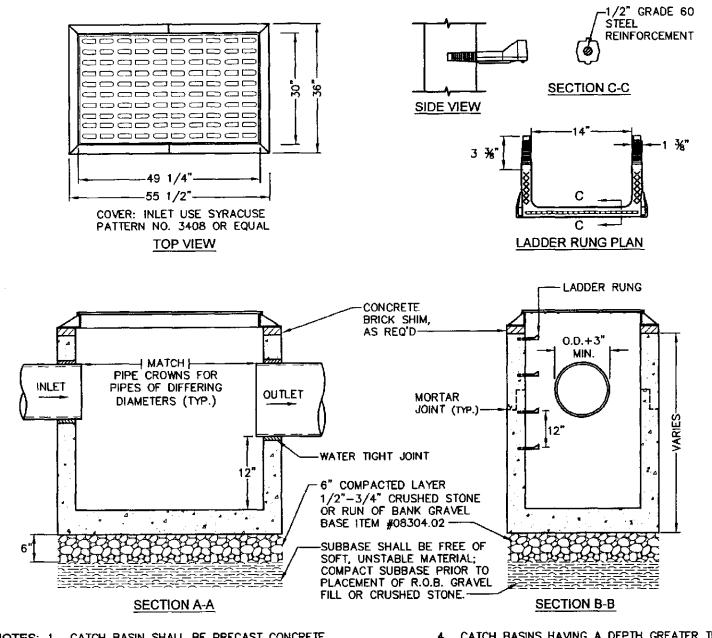

NOTES: 1. CATCH BASIN SHALL BE PRECAST CONCRETE.


DESIGNED FOR H-20 VEHICULAR LOADING AND 25%
IMPACT.


FRAME AND COVER SHALL BE DESIGNED FOR H-20 VEHICULAR LOADING AND 25% IMPACT.
 CONCRETE CATCH BASIN CASTING CLEAR OPENING

3. CONCRETE CATCH BASIN CASTING CLEAR OPENING DIMENSION MUST MATCH FRAME AND GRATE CLEAR OPENING DIMENSION FOR H-20 VEHICULAR LOADING.

4. CATCH BASINS HAVING A DEPTH GREATER THAN
48" FROM FINISHED SURFACE TO THE TOP OF THE
CONCRETE BASE SHALL BE PROVIDED WITH STEPS.
5. BACKFILL USING SELECT MATERIAL, COMPACTED IN

6. SUMPS FOR CATCH BASINS SHALL BE 12".

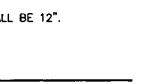

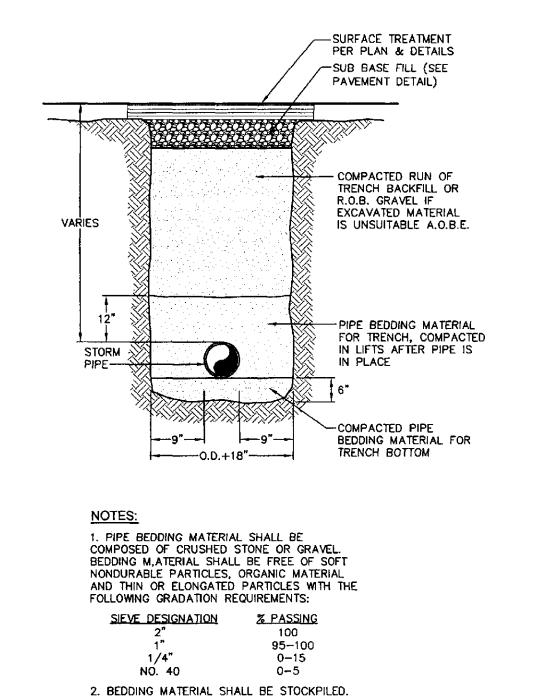

TYPICAL STORM
PIPE IN TRENCH DETAIL

SCALE: NOT TO SCALE

1 CATCH BASIN DETAIL
2 SCALE: NOT TO SCALE

STORM WATER MANAGEMENT AND EROSION CONTROL NOTES

1. ALL EROSION CONTROL MEASURES EMPLOYED DURING CONSTRUCTION PROCESS SHALL BE INSPECTED BY THE CONTRACTOR IN ACCORDANCE WITH THE EROSION AND SEDIMENT CONTROL MAINTENANCE SCHEDULE. ALL EROSION CONTROL STRUCTURES SHALL BE REPAIRED AND MAINTAINED AS NECESSARY BY THE CONTRACTOR.

2. ALL STORM WATER MANAGEMENT STRUCTURES (I.E. CATCH BASIN, ETC.) SHALL BE REGULARLY INSPECTED FOR SEDIMENT ACCUMULATIONS. CATCH BASIN SHALL BE CLEANED WHEN SEDIMENT DEPTH REACHES A MAXIMUM OF 1/2 THE AVAILABLE SUMP DEPTH.

3. IF THE CONSTRUCTION PROCESS EXPOSES SIGNIFICANT SOIL AREAS (NO MORE THAN 5 ACRES) FOR ANY LENGTH OF TIME, INCREASED POTENTIAL FOR EROSION AND DUST CREATION WILL OCCUR. THE CONTRACTOR SHALL PROVIDE, AT THE TOWN ENGINEERS DIRECTION, SUPPLEMENTAL SURFACE TREATMENTS (SUCH AS HAY BALE LINES, TEMPORARY SWALES, RIP—RAP INTERCEPT POOLS, AND DUST CONTROL MEASURES) MAY BE REQUIRED.

4. ALL EROSION CONTROL INSTALLATION AND MAINTENANCE MEASURES SHALL MEET THE REQUIREMENTS OF THE NEW YORK STATE SOIL AND WATER CONSERVATION SOCIETY DOCUMENT "GUIDELINES FOR URBAN EROSION AND SEDIMENT CONTROL," UNITED STATES DEPARTMENT OF TRANSPORTATION, FEDERAL HIGHWAY ADMINISTRATION GUIDELINES, AND THE LATEST "URBAN EROSION AND SEDIMENT CONTROL GUIDE BOOK" OF THE DUTCHESS COUNTY SOIL AND WATER CONSERVATION DISTRICT.

5. ANY PILE OF CONSTRUCTION DEBRIS, PARKING LOT MACADAM, OR OTHER POTENTIALLY EROSIVE MATERIAL TEMPORARILY STOCKPILED ON THE SITE DURING THE CONSTRUCTION PROCESS SHALL BE LOCATED IN AN AREA AWAY FROM STORM DRAINAGE AND SHALL BE PROPERLY PROTECTED FROM EROSION BY A SURROUNDING SILT FENCE OR HAY BALE BARRIER.

6. PERMANENT SEEDED AREAS FOR EROSION CONTROL SHALL BE IN ACCORDANCE WITH THIS SHEET.

7. AREAS UNDERGOING CLEARING OR GRADING AND WHERE WORK IS DELAYED OR COMPLETED AND WILL NOT BE RE-DISTURBED FOR A PERIOD OF 21 DAYS OR MORE SHALL BE STABILIZED WITH TEMPORARY OR PERMANENT VEGETATIVE COVER WITHIN 14 DAYS. MAINTENANCE SHALL BE PERFORMED AS NECESSARY TO ENSURE CONTINUED STABILITY. TEMPORARY COVER: RAPIDLY GERMINATING ANNUAL GRASS = 30 LBS PER ACRE. PERENNIAL RYE GRASS = 100 LBS PER ACRE. CEREAL RYE = 30 LBS PER ACRE. PERMANENT COVER: SEE DETAIL THIS SHEET.

8. GRADE AS NEEDED AND FEASIBLE TO PERMIT THE USE OF CONVENTIONAL EQUIPMENT FOR SEED BED PREPARATION, SEEDING AND MULCH APPLICATION.

9. WHERE TOPSOIL IS TO BE PLACED, REMOVE REFUSE, WOODY PLANT PARTS, STONES OVER 3" IN DIAMETER, AND OTHER LITTER FROM UNDERLYING SOIL SURFACE. SCARIFY ALL COMPACTED SOILS PRIOR TO APPLYING TOPSOIL.

10. TOPSOIL SHALL BE DISTRIBUTED TO A UNIFORM DEPTH OVER THE TREATED AREA. IT SHALL NOT BE PLACED WHEN IT IS PARTLY FROZEN, MUDDY OR ON FROZEN SLOPES OR OVER ICE, SNOW, OR STANDING WATER PUDDLES.

11. ON-SITE DUST CONTROL SHALL BE ACCOMPLISHED BY STANDARD METHODS OF LIGHTLY WATERING ALL EXPOSED SOIL AND RAPIDLY STABILIZING THE REGRADED AREAS WITH TOPSOIL, LOAM AND/OR SEEDING.

12. THE TOWN ENGINEER, TOWN WATER DEPARTMENT, TOWN SEWER DEPARTMENT, TOWN BUILDING DEPARTMENT AND PROJECT ENGINEER SHALL BE NOTIFIED NO LESS THAN 48 HOURS PRIOR TO THE START OF ANY SITE WORK AND BY SUCH NOTIFICATION SHALL BE PROVIDED WITH THE NAME AND TELEPHONE NUMBER OF THE GENERAL CONTRACTOR RESPONSIBLE FOR SUCH

13. THE TOWN ENGINEER MAY INSPECT EROSION AND SEDIMENT CONTROL PRACTICES ON THE SITE DURING CONSTRUCTION AND RECOMMEND THAT THE CONTRACTOR INSTALL ADDITIONAL EROSION CONTROL MEASURES IF DEEMED NECESSARY TO PROTECT ANY UNDISTURBED AREAS OF THE SITE. ANY SUCH REQUESTS SHALL BE MADE DIRECTLY TO THE CONTRACTOR AND FOLLOWED UP WITH A WRITTEN NOTIFICATION TO THE DEVELOPER. IN ADDITION, THE TOWN ENGINEER AND QUALIFIED PROFESSIONAL (SEE NOTES 14 AND 15) SHALL BE CONSULTED ON ANY SPECIAL ADDITIONS OR DELETIONS OF EROSION CONTROL MEASURES WARRANTED BY CHANGING FIELD CONDITIONS. THE NYSDEC NOI MAY NEED TO BE UPDATED AS A RESULT OF THESE CHANGES.

14. THE CONTRACTOR/OWNER SHALL HAVE A QUALIFIED PROFESSIONAL, AS DESCRIBED WITHIN THE NYSDEC SPDES GENERAL PERMIT FOR STORMWATER DISCHARGES FROM CONSTRUCTION ACTIVITY PERMIT NO. GP-02-01, CONDUCT SITE INSPECTIONS PRIOR TO CONSTRUCTION FOLLOWING THE COMMENCEMENT OF CONSTRUCTION AT LEAST EVERY 7 CALENDAR DAYS AND WITHIN 24 HOURS OF THE END OF A STORM EVENT OF 0.5 INCHES OR GREATER. REFER TO SPPP FOR WHAT EACH INSPECTION SHALL CONSIST OF.

15. PRIOR TO COMMENCEMENT OF CONSTRUCTION, A QUAILIFIED PROFESSIONAL IN SEDIMENT AND EROSION CONTROL (HIRED BY CONTRACTOR/OWNER) SHALL CONDUCT AN ASSESSMENT OF THE SITE AND CERTIFY THAT THE APPROPRIATE EROSION AND SEDIMENT CONTROL STRUCTURES AS DEPICTED ON THE PLANS HAVE BEEN ADEQUATELY INSTALLED AND IMPLEMENTED. CONTRACTOR SHALL CONTACT THE PROJECT ENGINEER ONCE THE EROSION AND SEDIMENT CONTROL STRUCTURES HAVE BEEN INSTALLED. REFER TO 'STORMWATER POLLUTION PREVENTION PLAN' FOR WHAT EACH INSPECTION SHALL CONSIST OF.

16. THE CONTRACTOR/OWNER SHALL MAINTAIN A RECORD OF ALL EROSION AND SEDIMENT CONTROL INSPECTION REPORTS AT THE SITE IN A LOG BOOK. THE SITE LOG BOOK SHALL BE MAINTAINED ON—SITE AND BE MADE AVAILABLE TO THE PERMITTING AUTHORITY. THE OWNER/CONTRACTOR SHALL POST AT THE SITE, IN A PUBLICLY—ACCESSIBLE LOCATION, A SUMMARY OF THE SITE INSPECTION ACTIVITIES ON A MONTHLY BASIS.

17. CONTRACTOR/OWNER SHALL FILE A NOTICE OF INTENT (NOI) WITH THE NYSDEC PRIOR TO COMMENCING CONSTRUCTION ACTIVITIES AND A NOTICE OF TERMINATION (NOT) WITH NYSDEC FOLLOWING CONSTRUCTION ACTIVITIES.

18. IF GROUNDWATER IS ENCOUNTERED DURING CONSTRUCTION ACTIVITIES, THE CONTRACTOR SHALL CONSTRUCT A DEWATERING PIT (A.K.A. SUMP PIT) TO TRAP AND FILTER WATER FOR PUMPING TO A SUITABLE DISCHARGE AREA. THE DEWATERING PIT SHALL BE CONSTRUCTED IN ACCORDANCE WITH THE NEW YORK STATE GUIDELINES FOR URBAN EROSION AND SEDIMENT CONTROL, LATEST EDITION.

19. WHEN ALL DISTURBED AREAS ARE STABLE, ALL TEMPORARY EROSION AND SEDIMENT CONTROL MEASURES SHALL BE REMOVED PER THE APPROVAL OF THE TOWN ENGINEER.


20. UPON COMPLETION OF CONSTRUCTION; THE OWNER SHALL BE RESPONSIBLE FOR THE INSPECTION AND MAINTENANCE OF THE STORM WATER MANAGEMENT SYSTEM. THE STORM WATER MANAGEMENT SYSTEM SHALL BE INSPECTED QUARTERLY AND AFTER EACH SIGNIFICANT RAINFALL EVENT. THE OWNER SHALL MAINTAIN A RECORD OF INSPECTION AND MAINTENANCE REPORTS ON—SITE.

REFER TO SPPP FOR WHAT EACH INSPECTION SHALL CONSIST OF.

21. THE CONTRACTOR SHALL RESTORE GRASS AREAS AS DIRECTED BY THE OWNER AND THE ENGINEER.

22. DETAIL DIMENSIONS FOR STORMWATER QUALITY TREATMENT MEASURES ARE LOCATED IN THE STORM WATER POLLUTION PREVENTION PLAN (SWPPP) AND MEET THE REQUIREMENTS OF NYSDEC STORMWATER SPDES GP-02-01 PERMIT.



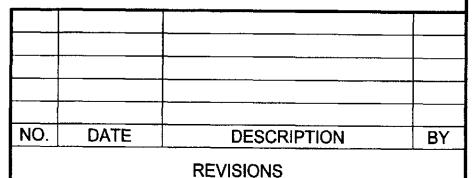

E N G I N E F R I N G 187 E. Market St., Ste 101, Rhinebeck, N.Y. 12572

Phone: (845) 876-5250 Fax: (845) 876-7209

www.dewkett.com

PROJECT NAME:

NEW WINDSOR
BUSINESS PARK
PROPOSED OFFICE BUILDING

TOWN OF NEW WINDSOR


Prepared for:
NEW WINDSOR BUSINESS PARK ASSOCIATES

TITLE OF DRAWING:

STORM SEWER DETAILS

| Project No: 05027.00 | Date: 06-07-05 | Scale: AS SHOWN | | | | | | |
|--|------------------------|--------------------|--|--|--|--|--|--|
| OF NEW DELLA | File Name: D1-05027 | DRAWING NO: | | | | | | |
| | Design By: DEC | Da | | | | | | |
| 20 mass? | Checked By: KAD | By D2 | | | | | | |
| NOTESSION OF THE PROPERTY OF THE PARTY OF TH | Drafted By: DEC | Sheet 8 of 11 | | | | | | |

REPRODUCTION OF THIS DOCUMENT IN WHOLE OR IN PART IS PROHIBITED EXCEPT WITH THE PERMISSION OF THE OFFICE OF ORIGIN.
UNAUTHORIZED ALTERATION OR ADDITION TO THIS PLAN IS A VIOLATION OF SECTION 7209 (2) OF THE NEW YORK STATE EDUCATION LAW.

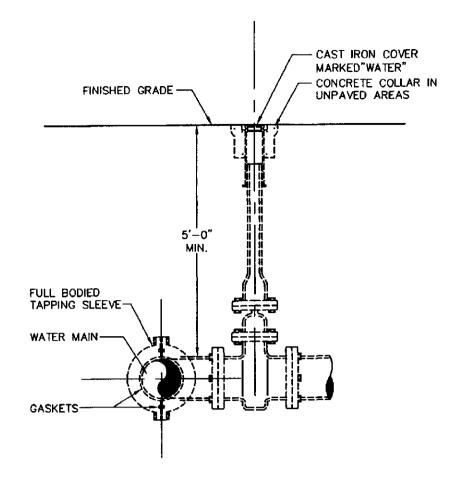

NOTES:

WET TAP OF PUBLIC WATER MAIN SHALL BE PERFORMED UNDER THE SUPERVISION OF REGULATORY AGENCY.
 TAPPING SLEEVE AND VALVE SUPPORT SHALL BE COORDINATED WITH REGULATORY AGENCY.
 MINIMUM DISTANCE TO JOINTS, FITTINGS OR OTHER WET TAPS OR STOPS SHALL BE MAINTAINED AS PER REGULATORY

03

TAPPING SLEEVE AND VALVE DETAIL
SCALE: NOT TO SCALE

SCHEDULE OF JOINT RESTRAINT

(NO. OF PIPE LENGTHS - 18' LENGTH)

PIPE SIZE (INCHES) 90' 45' 22 1/2' TEE

8" 4 2 1 4

6" 2 1 1 2

NOTES:

1. FOR PLUGS, RESTRAIN PIPE LENGTH GIVEN FOR 90°

2. LENGTH OF PIPE TO BE RESTRAINED IS THE LENGTH FOR EACH SIDE OF THE FITTING, IE: FOR 6"Ø PIPE A 90" BEND SHALL BE RESTRAINED TWO (2) LENGTHS ON EACH SIDE OF THE BEND.

3. WHERE WATERMAINS ARE TO BE DUCTILE IRON, ALL JOINTS SHALL BE RESTRAINED TYPE USING FIELD LOCK GASKETS AND MEGALUG OR MECHANICAL JOINTS. IN ACCORDANCE WITH THE LENGTHS SHOWN IN THE TABLE ABOVE.


4. SHOP DRAWINGS SHALL BE SUBMITTED TO ENGINEER FOR RESTRAINT SYSTEMS WITH PIPE SIZES LARGE THAN 8".

5. THE ABOVE CALCULATIONS ARE BASED ON 125 PSI WATER PRESSURE AND SOILS HAVING A BEARING CAPACITY OF 2000 POUNDS PER SQUARE FOOT.

JOINT RESTRAINT

SCHEDULE AND NOTES

D3 SCALE: NOT TO SCALE

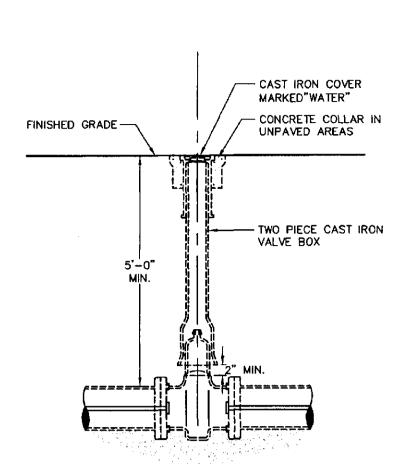


NOTES:

1. NON-RISING STEM GATE VALVE, OPERATING DIRECTION TO BE COORDINATED WITH WATER REGULATORY AGENCY.

2. MINIMUM DISTANCE TO JOINTS, FITTINGS OR OTHER WET TAPS OR STOPS SHALL BE MAINTAINED AS PER REGULATORY AGENCY.

2 TYPICAL GATE VALVE DETAIL
D3 SCALE: NOT TO SCALE

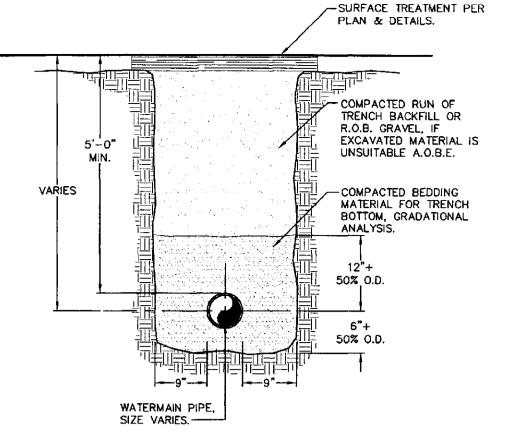

NOTES:


1. PIPE BEDDING SHALL BE A NATURAL RUN-OF-BANK
(R.O.B.) SAND GRADED FROM FINE TO COARSE PARTICLES, OR
A GRADED MIXTURE OF CRUSHED STONE OR CRUSHED GRAVEL.
BEDDING MATERIAL OR STONE GRADATIONS USED SHALL BE
APPROVED BY THE ENGINEER.

2. INSTALL CONTINUOUS DETECTABLE MARKING TAPE DURING BACKFILLING OF TRENCH FOR UNDERGROUND WATER SERVICE PIPING. LOCATE TAPE 12" BELOW FINISHED GRADE, DIRECTLY OVER PIPING.


3. THE PROPOSED WATERMAINS SHALL BE INSTALLED WITH A MINIMUM COVER OF FIVE (5) FEET AND SHALL BE CEMENT LINED DUCTILE IRON, CLASS 52.

4. SHEETING SHALL BE IMPLEMENTED IN ACCORDANCE WITH O.S.H.A. STANDARDS.

TYPICAL WATER PIPE
IN TRENCH DETAIL
SCALE: NOT TO SCALE

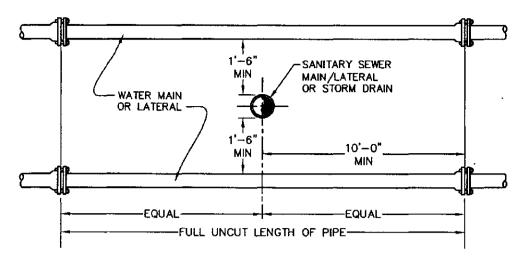

VERTICAL SEPARATION

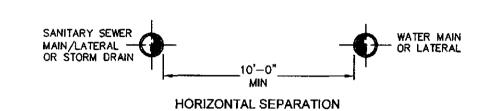

NOTE

1. NO DEVIATION IN THE SEPARATION REQUIREMENTS WILL BE PERMITTED WITHOUT THE EXPRESS APPROVAL OF THE ORANGE COUNTY DEPARTMENT OF HEALTH. CONCRETE ENCASEMENT OF WATERLINE OR OFFSETTING OF WATERLINE SHALL BE REQUIRED WHERE SEPARATION DISTANCES CANNOT BE MAINTAINED.

SANITARY/STORM SEWER AND
WATERMAIN SEPARATION DETAIL
D3 SCALE: NOT TO SCALE

WATER NOTES:

1. ALL WATER LINES SHALL BE DUCTILE IRON PIPE, CLASS 52 UNLESS OTHERWISE SPECIFIED BY OR APPROVED BY THE TOWN OF POUGHKEEPSIE WATER DEPARTMENT. JOINTING SHALL EMPLOY "MEGALUG" CONNECTIONS, LOCK-JOINT PIPE, OR AS ALTERNATIVELY SPECIFIED BY THE TOWN WATER DEPARTMENT. ALL WATER PIPING CONSTRUCTION SHALL BE TO THE SPECIFICATIONS OF THE TOWN WATER DEPARTMENT.

2. THE WATER LINE MAY BE FLEXED WITHIN PIPE SPECIFICATIONS OR LAID DEEPER IN AREAS WHERE CROSSINGS WITH THE SANITARY LINE OCCUR, TO ACHIEVE THE REQUIRED 1.5' VERTICAL SEPARATION DISTANCE. IF THIS DISTANCE CANNOT BE REASONABLY ACHIEVED, THE CONTRACTOR SHALL EITHER CUT AND JOINT THE PIPE OR CONCRETE ENCASE BOTH LINES 10' IN EACH DIRECTION. (SEE WATERLINE OFFSET DETAIL FOR FURTHER INFORMATION).

3. ALL NEW WATER MAIN INSTALLATIONS SHALL BE HYDROSTATICALLY TESTED PER AWWA STANDARD C 600(LATEST REVISION) AT A PRESSURE OF 150 PSI, OR 1.25 TIMES THE WORKING PRESSURE OF THE SYSTEM AS A MINIMUM. ALLOWABLE LEAKAGE OF THIS TEST SHALL BE AS DEFINED IN SECTION 4.2 OF SAID AWWA SPECIFICATION.


4. APPROVED AND TESTED WATER MAIN SHALL BE DISINFECTED PER AWWA SECTION C 601, AS DIRECTED BY THE TOWN WATER DEPARTMENT.

5. THE FACILITY WILL BE CONSTRUCTED WITH WATER CONSERVING PLUMBING

6. THE WATERMAIN IS TO BE INSTALLED AT A CONTINUOUS GRADE WITH NO ABRUPT HIGH OR LOW POINTS.



CALL BEFORE YOU DIG , DRILL OR BLAST NO LESS THAN TWO WORKING DAYS NOTICE IT'S THE LAW!

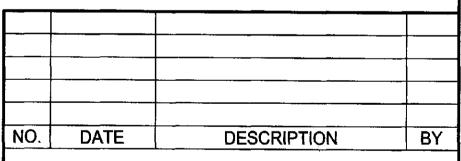

REVISIONS

DEWKETT

187 E. Market St., Ste 101, Rhinebeck, N.Y. 12572 Phone: (845) 876-5250 Fax: (845) 876-7209 www.dewkett.com

PROJECT NAME:

NEW WINDSOR BUSINESS PARK PROPOSED OFFICE BUILDING

TOWN OF NEW WINDSOR

Prepared for:
NEW WINDSOR BUSINESS PARK ASSOCIATES

TITLE OF DRAWING:

WATER DETAILS

Project No: 05027.00

Date:
06-07-05
File Name:
D1-05027
Design By:
DEC
Checked By

KAD

Drafted By:

DEC

D:

Sheet 9 of 11


AS SHOWN


DRAWING NO:


GRADE -4"x4"x1/4" STEEL PLATE W/3" SQUARE REFLECTIVE SHEETING (EACH SIDE) 4' HIGH #3 REBAR (3/8" DIÄ.)---2-1/2" DIA. LOOP AT THE END OF REBAR----- CAST IRON COVER MARKED "WATER" - CONCRETE COLLAR IN UNPAVED AREAS RISER LENGTH: AS REQUIRED NOTE: EXACT RISER LENGTH TO SUIT FIELD CONDITIONS AND CONFORM TO MANUFACTURER'S RECOMMENDATIONS.-LIMIT OF TRENCH ----6" GATE VALVE SEE DETAIL PROVIDE 1/2 YARD 3/4" SCREENED GRAVEL DRAIN VALVE ORIFICE-UNDISTURBED SOIL--3/4" Ø GALVANIZED STEEL RODS W/MALLEABLE IRON NUTS AT 6"ø DUCTILE IRON PIPE ---

6 HYDRANT ASSEMBLY DETAIL
D3 SCALE: NOT TO SCALE

REPRODUCTION OF THIS DOCUMENT IN WHOLE OR IN PART IS PROHIBITED EXCEPT WITH THE PERMISSION OF THE OFFICE OF ORIGIN.
UNAUTHORIZED ALTERATION OR ADDITION TO THIS PLAN IS A VIOLATION OF SECTION 7209 (2) OF THE NEW YORK STATE EDUCATION LAW.

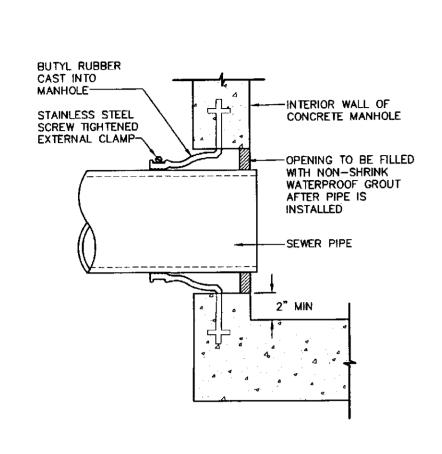


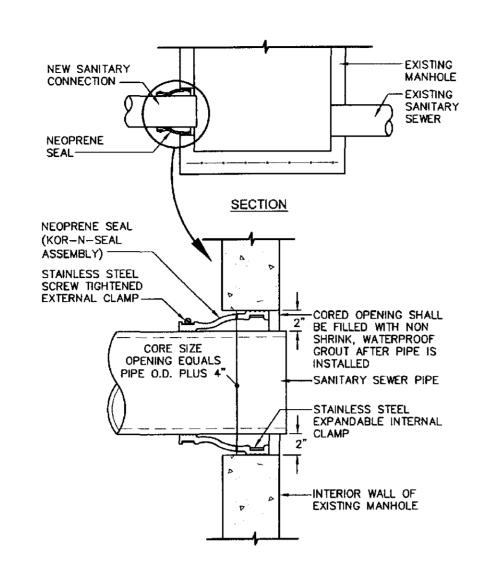

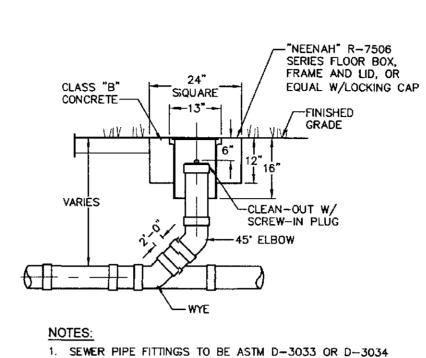

2. TO BE USED FOR GRAVITY PORTION OF SANITARY SYSTEM

AS WELL AS THE STORIM ROOF DRAINAGE SYSTEM.

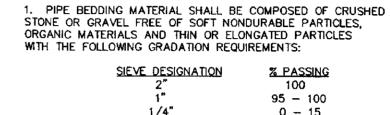

OUTSIDE

MINIMUM

VARIES

- SURFACE TREATMENT PER PLAN & DETAILS - GRAVEL FILL (SEE PAVEMENT DETAIL)

PLASTIC WARNING TAPE

LABLED 'SANITARY'

-COMPACTED RUN OF

R.O.B. GRAVEL IF

IS IN PLACE

-COMPACTED PIPE

TRENCH BOTTOM

0 - 5

TRENCH BACKFILL OR

UNSUITABLE A.O.B.E.

EXCAVATED MATERIAL IS

PIPE BEDDING MATERIAL

FOR TRENCH SHALL BE

COMPACTED AFTER PIPE

BEDDING MATERIAL FOR

 BEDDING MATERIAL SHALL BE STOCKPILED.
 INSTALL CONTINOUS PLASTIC UNDERGROUND WARNING TAPE DURING BACKFILLING OF TRENCH FOR UNDERGROUND SANITARY SERVICE PIPING. LOCATE 12 INCHES BELOW FINISHED GRADE, DIRECTLY OVER PIPING.


1 FLEXIBLE SLEEVE DETAIL
D4 SCALE: NOT TO SCALE


TYPICAL SANITARY MANHOLE ASSEMBLY DETAILS







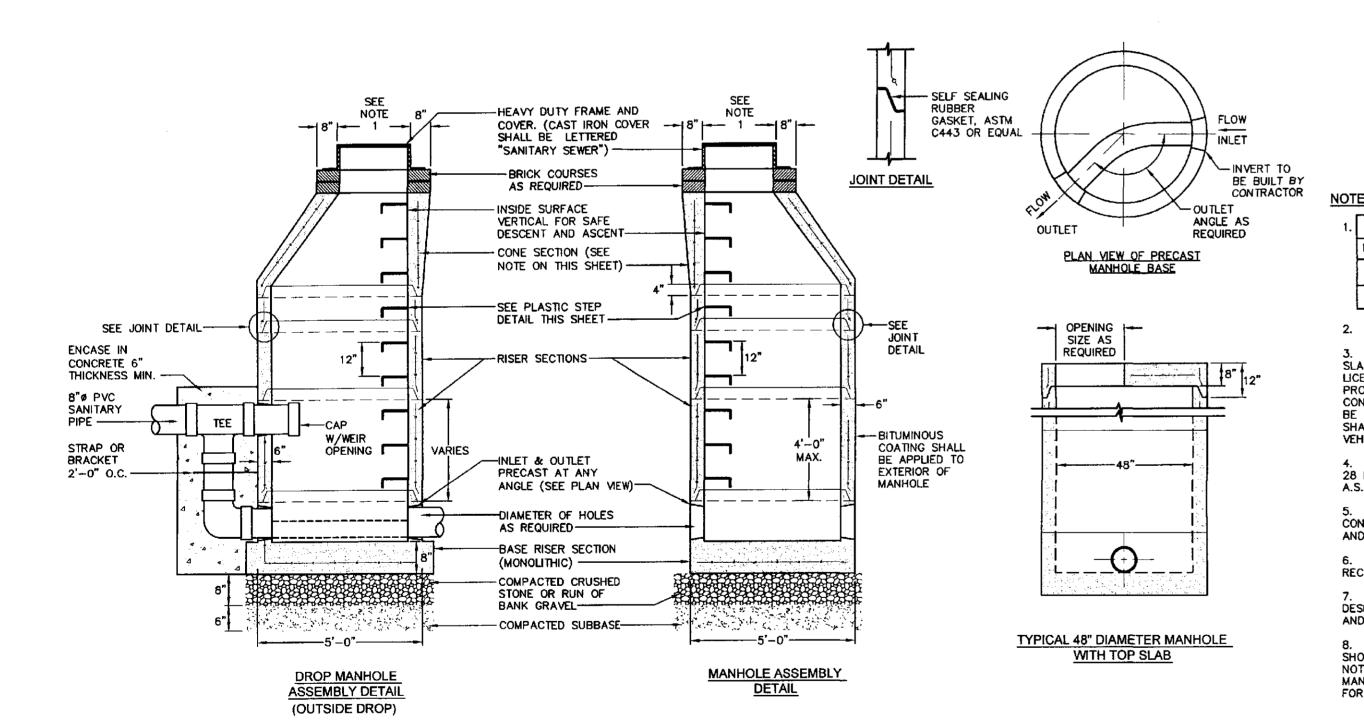

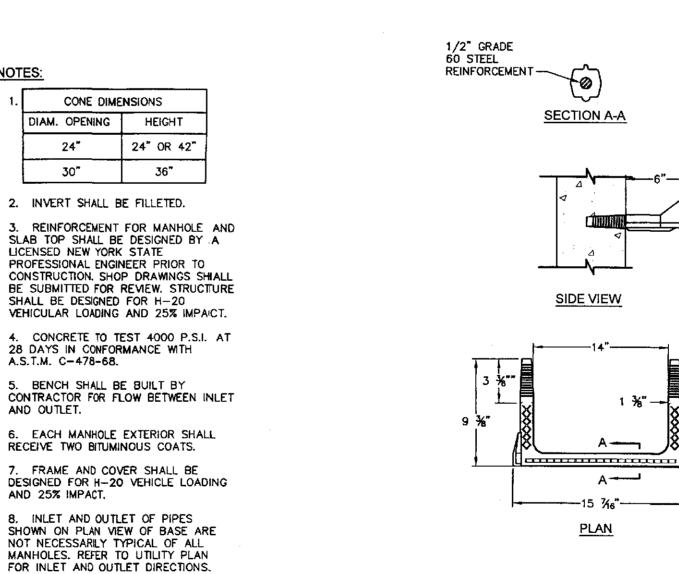



SANITARY NOTES:

1. ALL SANITARY GRAVITY PIPE SHALL BE SDR 35, ALL SANITARY FORCE MAINS SHALL BE SDR26 AND SHALL BE SEPARATED A MINIMUM OF TEN (10) HORIZONTAL FEET FROM THE WATERMAIN. IF FOR SOME REASON, THIS SEPARATION CANNOT BE ACHIEVED, SANITARY SEWER PIPE IN THIS AREA SHALL BE SDR 26 PRESSURE RATED PIPE. ALL SANITARY SEWER CONSTRUCTION SHALL BE TO THE SPECIFICATIONS OF THE TOWN SEWER DEPARTMENT.


2. ALL NEW SANITARY SEWER LINES SHALL PASS A LOW PRESSURE AIR TEST AND ALL NEW SANITARY SEWER MANHOLES SHALL PASS HYDROSTATIC TESTS AS DIRECTED BY THE TOWN SEWER DEPARTMENT.


3. ALL NEW SANITARY SEWER MANHOLE COVERS SHALL BE 24" DIAMETER CAST IRON AND SHALL READ "SANITARY SEWER".

4. ALL SANITARY SEWER SYSTEM COMPONENTS SHALL BE INSTALLED BY OR UNDER THE SUPERVISION OF A TOWN LICENSED PLUMBER IN ACCORDANCE WITH THE TOWN PLUMBING

5. ALL SANITARY SEWER CONSTRUCTION SHALL BE SUBJECT TO INSPECTION BY THE TOWN SANITARY SUPERINTENDENT PRIOR TO BACKFILLING. ALL NEW SANITARY FORCE MAIN INSTALLATIONS SHALL BE HYDROSTATICALLY TESTED PER AWWA STANDARD C 600-82 (LATEST REVISION) AT A PRESSURE OF 150 PSI. ALLOWABLE LEAKAGE OF THIS TEST SHALL BE AS DEFINED IN SECTION 4.2 OF SAID AWWA SPECIFICATION.

6. ALL NEW SANITARY FORCE MAIN INSTALLATIONS SHALL BE HYDROSTATICALLY TESTED PER AWWA STANDARD C 600-82 (LATEST REVISION) AT A PRESSURE OF 150 PSI. ALLOWABLE LEAKAGE OF THIS TEST SHALL BE AS DEFINED IN SECTION 4.2 OF SAID AWWA SPECIFICATION.

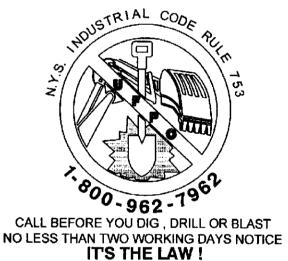

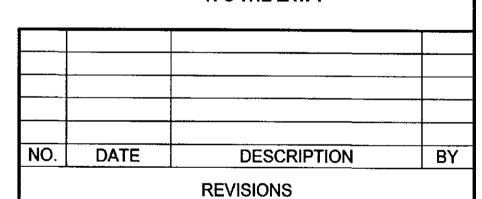



187 E. Market St., Ste 101, Rhinebeck, N.Y. 12572 Phone: (845) 876-5250 Fax: (845) 876-7209 www.dewkett.com

PROJECT NAME:

NEW WINDSOR
BUSINESS PARK
PROPOSED OFFICE BUILDING

TOWN OF NEW WINDSOR

Prepared for:

NEW WINDSOR BUSINESS PARK ASSOCIATES

TITLE OF DRAWING:

SANITARY SEWER DETAILS

Project No: 05027.00

Date:
06-07-05

File Name:
D1-05027

Design By:
DEC

Checked By:

KAD


Drafted By: Sheet 10 of 11

AS SHOWN

DRAWING NO:


REPRODUCTION OF THIS DOCUMENT IN WHOLE OR IN PART IS PROHIBITED EXCEPT WITH THE PERMISSION OF THE OFFICE OF ORIGIN.
UNAUTHORIZED ALTERATION OR ADDITION TO THIS PLAN IS A VIOLATION OF SECTION 7209 (2) OF THE NEW YORK STATE EDUCATION LAW.

SCALE: NOT TO SCALE

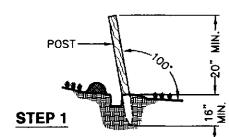


1. SET POSTS AND EXCAVATE A 1. STAPLE WIRE MESH FENCING 6"x6" TRENCH, SET POST TO FENCE POSTS. DOWNSLOPE.

2. ANGLE POST 10' UPSLOPE FOR STABILITY AND SELF CLEANING.

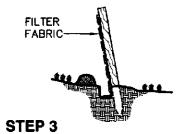

1. ATTACH FILTER FABRIC TO THE WIRE FENCING AND EXTEND IT INTO THE TRENCH.

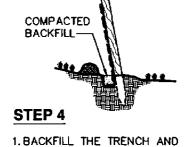

COMPACT THE EXCAVATED

FENCING—


1. FILTER FABRIC SHALL BE FASTENED SECURELY TO WOVEN WIRE FENCE WITH TIES SPACED EVERY 24" AT TOP AND MID SECTION.

2. WHEN TWO SECTIONS OF FILTER FABRIC ADJOIN EACH OTHER, THEY SHALL BE OVERLAPPED BY SIX INCHES AND FOLDED.


3. MAINTENANCE SHALL BE PERFORMED AS NEEDED AND MATERIAL REMOVED WHEN 'BULGES' DEVELOP IN THE SILT FENCE.

4. FENCE POSTS SHALL BE 'T' OR 'U' TYPE OR 2" HARDWOOD.


5. WIRE FENCE SHALL BE 14 1/2 GA., 6" MAX. MESH OPENING. 6. FILTER CLOTH SHALL BE MIRAFI 100X OR APPROVED EQUAL.

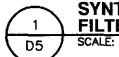

FILTER SEDIMENT BARRIER DETAIL

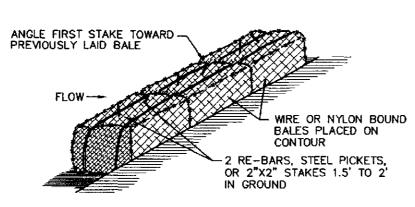

ANCHORING DETAIL

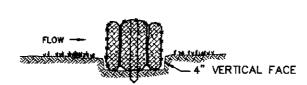

EMBEDDING DETAIL

CONSTRUCTION SPECIFICATIONS

1. BALES SHALL BE PLACED IN A ROW WITH ENDS TIGHTLY ABUTTING THE ADJACENT BALES.

2. EACH BALE SHALL BE EMBEDDED IN THE SOIL A MINIMUM


3. BALES SHALL BE SECURELY ANCHORED IN PLACE BY STAKES OR RE-BARS DRIVEN THROUGH THE BALES. THE FIRST STAKE IN EACH BALE SHALL BE ANGLED TOWARD PREVIOUSLY LAID BALE TO FORCE BALES TOGETHER.

4. INSPECTION SHALL BE FREQUENT AND REPAIR OR REPLACEMENT SHALL BE MADE PROMPTLY AS NEEDED.

5. BALES SHALL BE REMOVED WHEN THEY HAVE SERVED THEIR USEFULNESS SO AS NOT TO BLOCK OR IMPEDE STORM FLOW OR

6. HAY BALES SHALL BE PLACED IN ACCORDANCE WITH THE NEW YORK STATE GUIDELINES FOR URBAN EROSION AND SEDIMENT



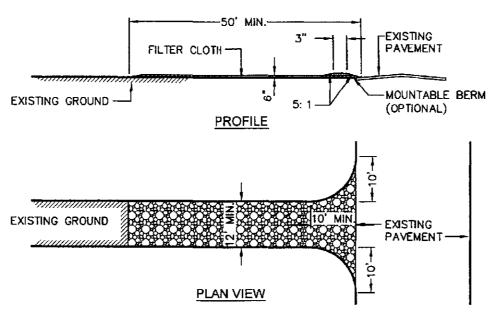

CONSTRUCTION ENTRANCE SPECIFICATIONS:

- 1. STONE SIZE USE 2" STONE, OR RECLAIMED OR RECYCLED CONCRETE EQUIVALENT.
- 2. THICKNESS NOT LESS THAN SIX (6) INCHES.
- 3. WIDTH TWELVE (12) FOOT MINIMUM, BUT NOT LESS THAN THE FULL WIDTH AT POINTS WHERE INGRESS OR EIGRESS OCCURS.
- 4. LENGTH AS REQUIRED, BUT NOT LESS THAIN 50'.
- 5. FILTER CLOTH WILL BE PLACED OVER THE ENTIRE AREA PRIOR TO PLACING OF STONE.
- 6. SURFACE WATER ALL SURFACE WATER FLOWING OR DIVERTED TOWARD CONSTRUCTION ENTRANCES SHALL BE PIPED ACROSS THE ENTRANCE. IF PIPING IS IMPRACTICAL, A MOUNTABLE BERM WITH 5:1 SLOPES WILL BE PERMITTED.
- 7. MAINTENANCE THE ENTRANCE SHALL BE MAINTAINED IN A CONDITION WHICH WILL PREVENT TRACKING OR FLOWING OF SEDIMENT ONTO PUBLIC RIGHTS-OF-WAY. THIS MAY REQUIRE PERIODIC TOP DRESSING WITH ADDITIONAL STONE AS CONDITTIONS DEMAND AND REPAIR AND/OR CLEANOUT OF ANY MEASURE'S USED TO TRAP SEDIMENT. ALL SEDIMENT SPILLED, DROPPED, WASHED OR TRACKED ONTO PUBLIC RIGHTS-OF-WAY MUST BE REMIOVED IMMEDIATELY.
- 8. WASHING WHEELS SHALL BE CLEANED TO REMOVE SEDIMENT PRIOR TO ENTRANCE ONTO PUBLIC RIGHTS-OF-WAY. WHEN WASHING IS REQUIRED, IT SHALL BE DONE ON AN AREA STABILIZED WITH STONE AND WHICH DRAINS INTO AN APPROVED SEDIMENT TRAPPING
- 9. PERIODIC INSPECTION AND NEEDED MAINTENANCE SHALL BE PROVIDED AFTER EACH RAIN.



| EROSION AI | EROSION AND SEDIMENT CONTROL MAINTENANCE SCHEDULE | | | | | | | |
|--|---|---------|-------------------|---|--|--|--|--|
| STRUCTURE | DAILY | WEEKLY | AFTER RAINFALL | NECESSARY TO MAINTAIN FUNCTION | AFTER COMPLETION OF CONSTRUCTION | | | |
| SILT FENCE BARRIER | | INSPECT | INSPECT | CLEAN/ REPLACE | REMOVE | | | |
| STABILIZED CONSTRUCTION ENTRANCE | INSPECT | | INSPECT | CLEAN/ REPLACE | REMOVE | | | |
| LANDLOCK 407GT | | INSPECT | INSPECT | REPAIR | PERMANANT | | | |
| CHECK DAMS | | INSPECT | INSPECT | CLEAN/ REPLACE STONE | REMOVE | | | |
| DUST CONTROL | INSPECT | | | MULCHING/ SPRAYING WATER | NA | | | |
| VEGETATIVE ESTABLISHMENT | | INSPECT | INSPECT | WATERING/ RE-SEEDING/ RE-MULCHING | PERMANENT | | | |
| RIPRAP OUTLET PROTECTION | | INSPECT | INSPECT | CLEAN/ REPLACE STONE | PERMANENT | | | |
| SEDIMENT TRAP | | INSPECT | INSPECT | REMOVE SEDIMENT/ REGRADING | REMOVE | | | |
| TEMPORARY DIVERSION SWALE | | INSPECT | INSPECT | REMOVE SEDIMENT/ RESEEDING | REMOVE | | | |
| HAY BALES | | INSPECT | INSPECT | REPLACE | REMOVE | | | |

MAINTENANCE OF EROSION CONTROL MEASURES

STABILIZED CONSTRUCTION ENTRANCE:
INSPECT THE ENTRANCE PAD EVERY SEVEN DAYS AND AFTER EVERY STORM EVENT THAT EQUALS OR EXCEEDS 1/2 INCH. CHECK FOR MUD, SEDIMENT BUILDUP, AND PAD INTEGRITY, MAKE DAILY INSPECTIONS DURING WET WEATHER. RESHAPE PAD AS NEEDED FOR DRAINAGE AND RUNOFF CONTROL. WASH AND REPLACE STONE AS NEEDED. THE STONE IN THE ENTRANCE SHOULD BE WASHED OR REPLACED WHENEVER THE ENTRANCE FAILS TO REDUCE MUD BEING CARRIED OFF-SITE BY VEHICLES. IMMEDIATELY REMOVE MUD AND SEDIMENT TRACKED OR WASHED ONTO PUBLIC ROADS BY BRUSHING OR SWEEPING. REMOVE TEMPORARY CONSTRUCTION ENTRANCE AS SOON AS THEY ARE NO LONGER NEEDED TO PROVIDE ACCESS TO THE SITE.

SILT FENCE: INSPECT FOR DAMAGE EVERY SEVEN DAYS AND AFTER EVERY STORM EVENT THAT EQUALS OR EXCEEDS 1/2 INCH. MAKE ALL REPAIRS IMMEDIATELY. REMOVE SEDIMENT FROM THE UP-SLOPE FACE OF THE FENCE BEFORE IT ACCUMULATES TO A HEIGHT EQUAL TO 1/3 THE HEIGHT OF THE FENCE. IF FENCE FABRIC TEARS, BEGINS TO DECOMPOSE, OR IN ANY WAY BECOMES INEFFECTIVE, REPLACE THE AFFECTED SECTION OF FENCE IMMEDIATELY. REMOVE SILT FENCE AS PER APPROVAL OF TOWN ENGINEER AND PROJECT ENGINEER.

SOIL STOCKPILE:

INSPECT SEDIMENT CONTROL BARRIERS (SILT FENCE OR HAYBALE) AND VEGETATION FOR DAMAGE EVERY SEVEN DAYS AND AFTER EVERY STORM EVENT THAT EQUALS OR EXCEEDS 1/2 INCH. MAKE ALL REPAIRS IMMEDIATELY. REMOVE SEDIMENT FROM THE UP-SLOPE FACE OF THE SEDIMENT CONTROL BARRIER BEFORE IT ACCUMULATES TO A HEIGHT EQUAL TO 1/3 THE HEIGHT OF THE SEDINMENT CONTROL BARRIER. IF SEDIMENT CONTROL BARRIER TEARS, BEGINS TO DECOMPOSE. OR IN ANYWAY BECOMES INEFFECTIVE. REPLACE THE AFFECTED SECTION OF SEDIMENT CONTROL BARRIER IMMEDIATELY. REVEGETATE DISTURBED AREA TO STABILIZE SOIL STOCK PILE. REMOVE THE SEDIMENT CONTROL BARRIER WHEN THE SOIL STOCKPILE HAS BEEN REMOVED.

<u>DUST_CONTROL</u>:
SCHEDULE CONSTRUCTION OPERATIONS TO MINIMIZE THE AMOUNT OF DISTURBED AREAS AT ANY ONE TIME DURING THE COURSE OF WORK. APPLY TEMPORARY SOIL STABILIZATION PRACTICES SUCH AS MULCHING, SEEDING AND SPRAYING (WATER). STRUCTURAL MEASURES (MULCH, SEEDING) SHALL BE INSTALLED IN DISTURBED AREAS BEFORE SIGNIFICANT BLOWING PROBLEMS DEVELOP. WATER SHALL BE SPRAYED AS NEEDED. REPEAT AS NEEDED, BUT AVOID EXCESSIVE SPRAYING, WHICH COULD CREATE RUNOFF AND EROSION PROBLEMS.

CHECK DAM:
INSPECT CHECK DAMS EVERY SEVEN DAYS AND AFTER EVERY STORM EVENT HAT EQUALS OR EXCEEDS 1/2 INCH. IF SIGNIFICANT EROSION HAS CCURRED BETWEEN STRUCTURES A LINER OF STONE OR OTHER SUITABLE MATERIAL SHOULD BE INSTALLED IN THAT PORTION OF THE CHANNEL, REMOVE SEDIMENT ACCUMULATED BEHIND THE DAM AS NEEDED TO ALLOW CHANNEL TO DRAIN THROUGH THE STONE CHECK DAM AND PREVENT LARGE FLOWS FROM CARRYING SEDIMENT OVER THE DAM. REPLACE STONES AS NEEDED TO MAINTAIN THE DESIGN CROSS SECTION OF THE STRUCTURES. REMOVE CHECK DAMS AS PER APPROVAL OF TOWN ENGINEER AND PROJECT ENGINEER.

(IF REQUIRED)-INSPECT DAILY DURING OPERATION FOR CLOGGING OR OVERFLOW. CLEAR INLET AND DISCHARGE PIPES OF OBSTRUCTIONS. IF A FILTER MATERIAL BECOMES CLOGGED WITH SEDIMENT, PIT SHALL BE DISMANTLED AND CONSTRUCT NEW PITS AS NEEDED.

STONE FILTER: SEE MAINTENANCE SCHEDULE FOR CHECK DAMS.



IT'S THE LAW!

NO. DATE DESCRIPTION BY **REVISIONS**

187 E. Market St., Ste 101, Rhinebeck, N.Y. 12572 Phone: (845) 876-5250 Fax: (845) 876-7209 www.dewkett.com

PROJECT NAME:

NEW WINDSOR BUSINESS PARK PROPOSED OFFICE BUILDING

TOWN OF NEW WINDSOR

Prepared for:

NEW WINDSOR BUSINESS PARK ASSOCIATES

TITLE OF DRAWING:

SEDIMENTATION AND EROSION **CONTROL DETAILS**

Project No: 05027.00 Drafted By:

06-07-05 File Name: D1-05027 Design By DEC Checked By KAD


DEC

Sheet 11 of 11

AS SHOWN

DRAWING NO:

REPRODUCTION OF THIS DOCUMENT IN WHOLE OR IN PART IS PROHIBITED **EXCEPT WITH THE PERMISSION OF** THE OFFICE OF ORIGIN. UNAUTHORIZED ALTERATION OR ADDITION TO THIS PLAN IS A VIOLATION OF SECTION 7209 (2) OF THE NEW YORK STATE EDUCATION LAW.

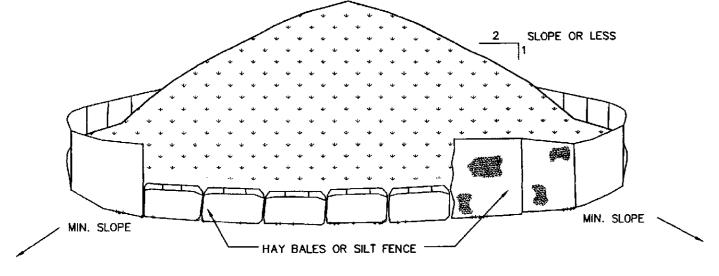

INSTALLATION NOTES

- 1. AREA CHOSEN FOR STOCKPILING OPERATIONS SHALL BE DRY AND STABLE.
- 2. MAXIMUM SLOPE OF STOCKPILE SHALL BE 1 : 2.
- 3. UPON COMPLETION OF SOIL STOCKPILING, EACH PILE SHALL BE SURROUNDED WITH EITHER SILT FENCING OR HAY BALES, THEN STABILIZED WITH VEGETATION
- 4. SEE SPECIFICATIONS FOR INSTALLATION OF SILT FENCE AND HAY BALES.

